MCHENRY COUNTY COLLEGE

LIEBERT SYSTEM REPLACEMENT

8900 US HWY 14 CRYSTAL LAKE, IL 60012

DKA PROJECT NO: 24-014

ISSUED FOR BID - NOT FOR CONSTRUCTION 4/25/2024



ARCHITECT:

DEMONICA KEMPER ARCHITECTS 125 N. HALSTED ST., SUITE 301 CHICAGO, IL 60661 T: 312.496.0000 F: 312.496.0001 MEP-FP ENGINEER

20/10 ENGINEERING GROUP, LLC 1216 TOWER ROAD SCHAUMBURG, IL 60173 P: 847.882.2010

ABBREVIATIONS

CLR

CLO

CONC

CONN

CONST

CONT

CONTR

CNSK CRS

DEPT

DISP

DIV

DBL DS

DRW

DS

EIFS

ELVTR

EP PT

EXSTG

EXPD

FS

FUTR

GALV

GEN

GD

GND

EXP

CK

CLEAR

CLOSET

COLUMN

CONCRETE

CONNECTION

CORRIDOR

COURSE

COUNTERSUNK

DEPARTMENT

DEAD LOAD

DIAMETER

DIMENSION

DISPENSER

DOOR OPENING

DRINKING FOUNTAIN

DETECTABLE WARNING TILE

EXTERIOR INSULATION FINISH SYSTEM

ELECTRICAL TRADES CONTRACTOR

ELECTRICAL WATER COOLER

ELECTRICAL PANEL BOARD

DRY STANDPIPE

ELECTRICAL

ELEVATION ELEVATION

ELEVATOR

ENCLOSURE

EMERGENCY

EPOXY PAINT

EXISTING

EXTERIOR

EXPANSION

EXPANSION JOINT

FACE OF CONCRETE

FINISH OR FINISHED

FIRE EXTINGUISHER

FIRE HOSE CABINET

FIBERGLASS REINFORCED PANEL

FIRE EXTINGUISHER CABINET

FACE OF FINISH

FACE OF STUD

FIRE ALARM

FIREPROOF

FLOOR FLOOR DRAIN

FLAT BAR STOCK

FLUORESCENT

FOOT OR FEET FOOTING

FOUNDATION

FRAMING

FULL SIZE

FURRING

FUTURE

GALVANIZED

GENERAL

GROUND GYPSUM BOARD

FABRIC WALLCOVERING

GENERAL CONTRACTOR

GLASS OR GLAZING

GENERAL TRADES CONTRACTOR

EPOXY FLOORING

EQUIPMENT

DIVISION

DOOR

DOUBLE DOWNSPOUT

DRAWER DRAWING

CONSTRUCTION

CONSTRUCTION MANAGER

CONTINUOUS OR CONTINUE

CONTRACTOR

DEMOLISH OR DEMOLITION

7 1001 1					
AD	ACCECC DANIEL	LIDIA	HARRIMARE	TEI	TELEBLIONE
AP	ACCESS PANEL	HDW	HARDWARE	TEL	TELEPHONE
ACOUST	ACOUSTICAL CEILING THE	HDWD	HARDWOOD	TV	TELEVISION
ACT	ACOUSTICAL CEILING TILE	HDR	HEADER	TRZ	TERRAZZO
ADJ	ADJACENT	HTG	HEATING VENTUATING AIR CONDITIONING	TB	TILE BASE
A.F.F.	ABOVE FINISH FLOOR	HVAC	HEATING, VENTILATING, AIR CONDITIONING	THK	THICK
AGGR	AGGREGATE	HT	HEIGHT	T.O.C.	TOP OF CURB
A/C	AIR CONDITIONING	HC	HOLLOW CORE	TOP	TOP OF PAVEMENT
ALT	ALTERNATE	HM	HOLLOW METAL	TOW	TOP OF WALL
ALUM	ALUMINUM	HMF	HOLLOW METAL FRAME	T&G	TONGUE AND GROOVE
L	ANGLE	HORZ	HORIZONTAL	TYP	TYPICAL
APPD	APPROVED	HB	HOSE BIB		LINENHOLIER
APPROX	APPROXIMATE	HR	HOUR	UNF	UNFINISHED
ARCH	ARCHITECTURAL OR ARCHITECT		MOLUPE	U.N.O.	UNLESS NOTED OTHERWISE
AD	AREA DRAIN	INC	INCLUDE	UR	URINAL
ASB	ASBESTOS	I.D.	INSIDE DIAMETER		
ASPH	ASPHALT	INSUL	INSULATION	VB	VINYL BASE
A/V	AUDIO VISUAL	INTR	INTERIOR	VERT	VERTICAL
		INV	INVERT	VEST	VESTIBULE
BSMT	BASEMENT			VCT	VINYL COMPOSITION TILE
BRG	BEARING	JAN	JANITOR	VW	VINYL WALLCOVERING
BM	BEAM	JT	JOINT		
BTW	BETWEEN	KIT	KITCHEN	WSCT	WAINSCOT
BITUM	BITUMINOUS	LAM	LAMINATE	WC	WATER CLOSET
BLK	BLOCK	LAV	LAVATORY	WLK	WALK-OFF MAT
BLKG	BLOCKING	LH	LEFT HAND	WR	WATER RESISTANT
BD	BOARD	LGTH	LENGTH	WT	WALL TILE OR WEIGHT
BRK	BRICK	LT	LIGHT	W	WEST
BLDG	BUILDING	LWC	LIGHT WEIGHT CONCRETE	W	WIDE FLANGE "W16x21"
		LTL	LINTEL	W	WIDTH
CAB	CABINET	LN	LINOLEUM	W/	WITH
CIP	CAST IN PLACE	LL	LIVE LOAD	W/O	WITHOUT
CIPC	CAST IN PLACE CONCRETE			WD	WOOD
CI	CURB INLET	MH	MANHOLE	WDP	WOOD PANEL
CB	CATCH BASIN	MFR	MANUFACTURER	Χ	EXISTING
CLG	CEILING	MAS	MASONRY		
CTR	CENTER	MO	MASONRY OPENING		
CJ	CONTROL JOINT	MTL	METAL		
CL	CENTER LINE	MAX	MAXIMUM		
CPT	CARPET	MECH	MECHANICAL		
CT	CERAMIC TILE	MTC	MECHANICAL TRADES CONTRACTOR		
OLD.	OLEAD	MEMO	MEMODANE		

MEMBRANE

MARBLE TILE

MISCELLANEOUS

NOT IN CONTRACT NOT TO SCALE

MINIMUM

MOUNDED

MOUNTING

MULLION

NOMINAL NORTH

NUMBER

OBSCURE

ON CENTER

OPENING

OPPOSITE

OVERALL

PAINTED

PAIR

ORIENTED STRAND BOARD

OUTSIDE DIAMETER

OVERFLOW DRAIN

PARTICLE BOARD

PLASTIC LAMINATE

PLYWOOD POUNDS PER SQUARE INCH

PRECAST CONCRETE

RAIN WATER LEADER

PLUMBING TRADES CONTRACTOR

PARTITION

PLASTIC

PRECAST

RADIUS

REGISTER

REINFORCED

REQUIRED

RESILIENT

RETURN AIR

RIGHT HAND RIGHT OF WAY

ROOF DRAIN

ROUGH OPENING

RUBBER BASE

RISER

ROOM

SECTION

SCHEDULE

SHEATHING

SHEET VINYL

SEALED CONCRETE

SPECIFICATION

STAINLESS STEEL

SINGLE PLY MEMBRANE

STRUCTURE OR STRUCTURAL

SUSPENDED ACOUSTICAL TILE

SPRAY APPLIED FIRE RESISTIVE MATERIAL

SHOWER

SIMILAR

SQUARE

STATION

STEEL

STORAGE

SUSPENDED

SYMMETRICAL

SINK

SHEET

RETURN AIR GRILLE

QUARRY TILE

REFRIGERATOR

OFFICE

MTD

NO OR #

OA

PBD

PTN

PLAS

PTC

RGTR

REINF

RQD

RB

SCHED

SPM


SFRM

STA

STL

STOR

STRUCT SUSP

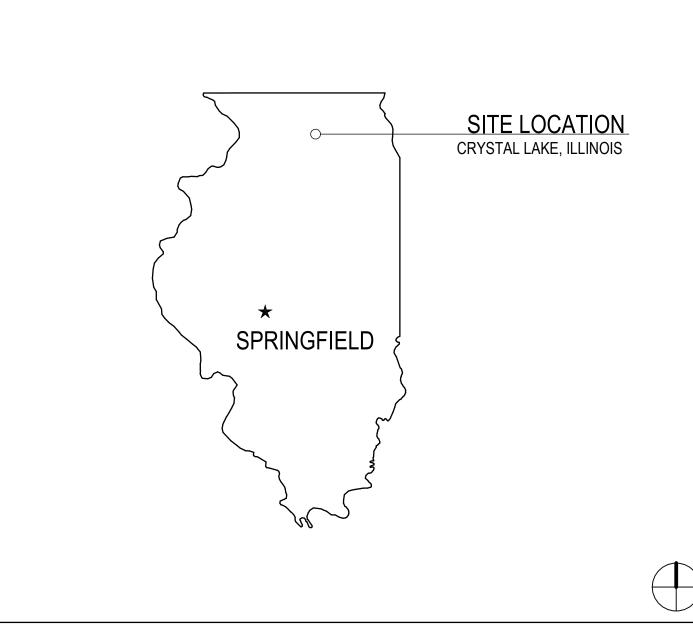

SHEET INDEX

GENERAL

ARCHITECTURAL

MECHANICAL

ELECTRICAL

ELECTRICAL DEMOLITION PLANS E1.00 OVERALL ELECTRICAL PLANS ELECTRICAL PLAN ELECTRICAL SYMBOL LIST, NOTES, AND SCHEDULES ELECTRICAL DETAILS, NOTES, AND SPECIFICATIONS

AD1.10 OVERALL PLANS, DEMO PLAN, AND DEMO RCP

DEMOLITION HVAC PLANS


HVAC PLANS


FLOOR PLAN AND REFLECTED CEILING PLAN

MEP COORDINATION NOTES AND DETAILS

HVAC SCHEDULES, DETAILS, AND NOTES

SHEET INDEX, ABBREVIATIONS, SYMBOLS & NOTES

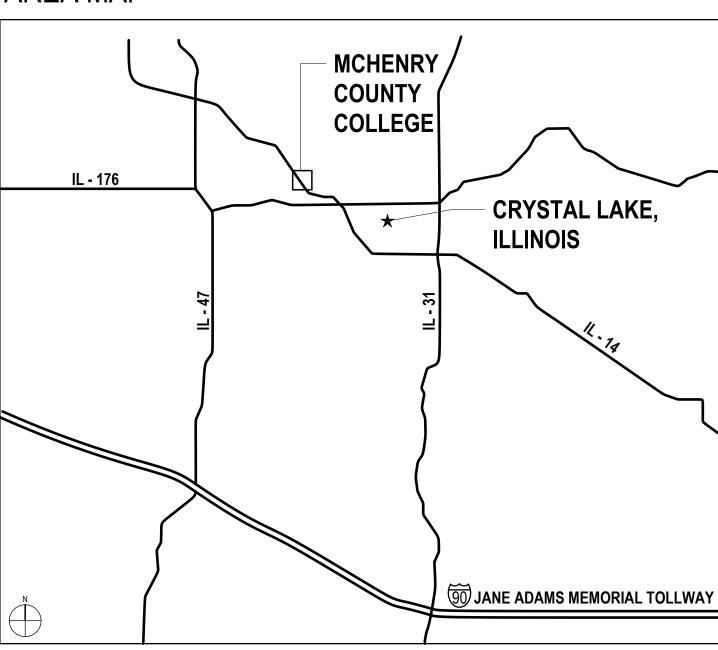

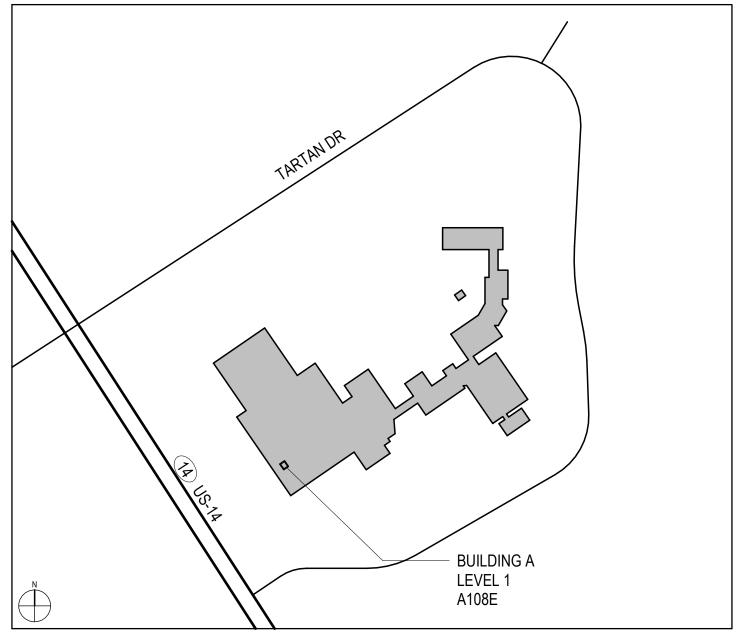




ARCHITECT OF RECORD DEMONICA KEMPER ARCHITECTS 125 N. HALSTED STREET, SUITE 301 **CHICAGO, IL 60661** P: 312.496.0000

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KEY PLAN:

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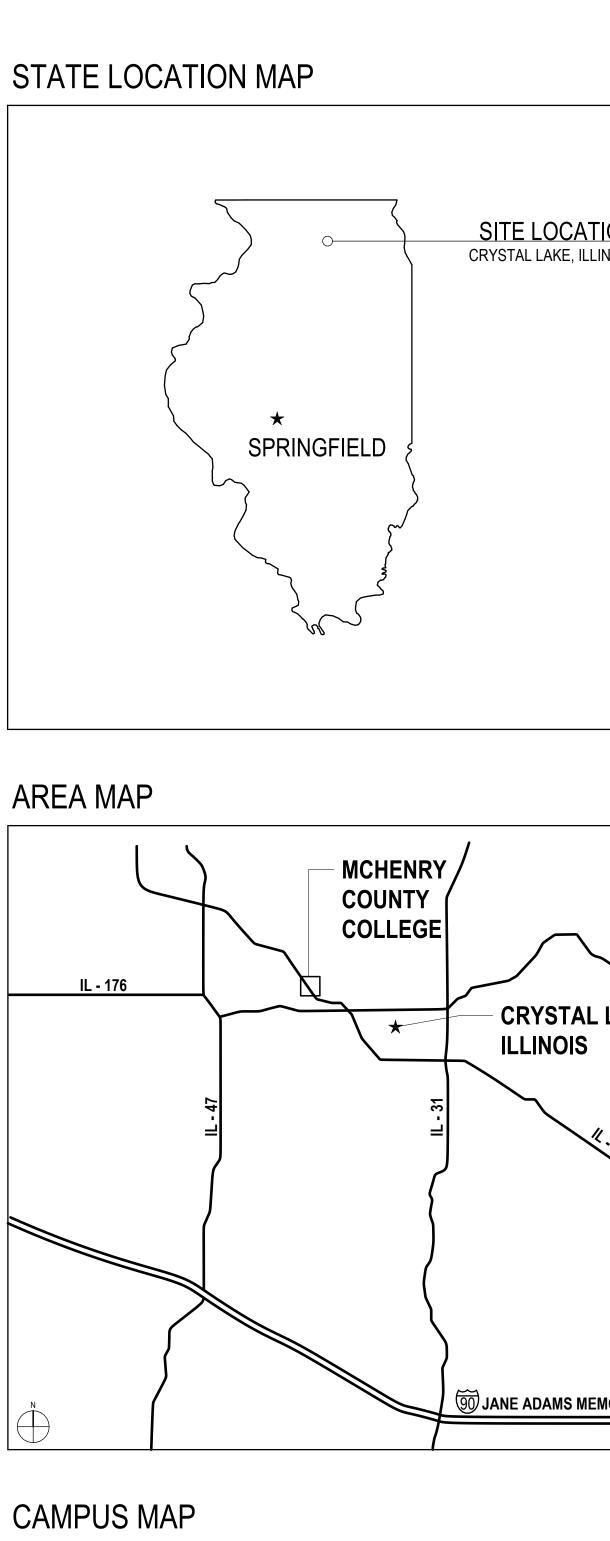



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SHEET INDEX, ABBREVIATIONS, **SYMBOLS & NOTES**

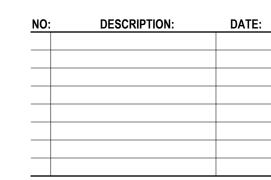SHEET NUMBER:

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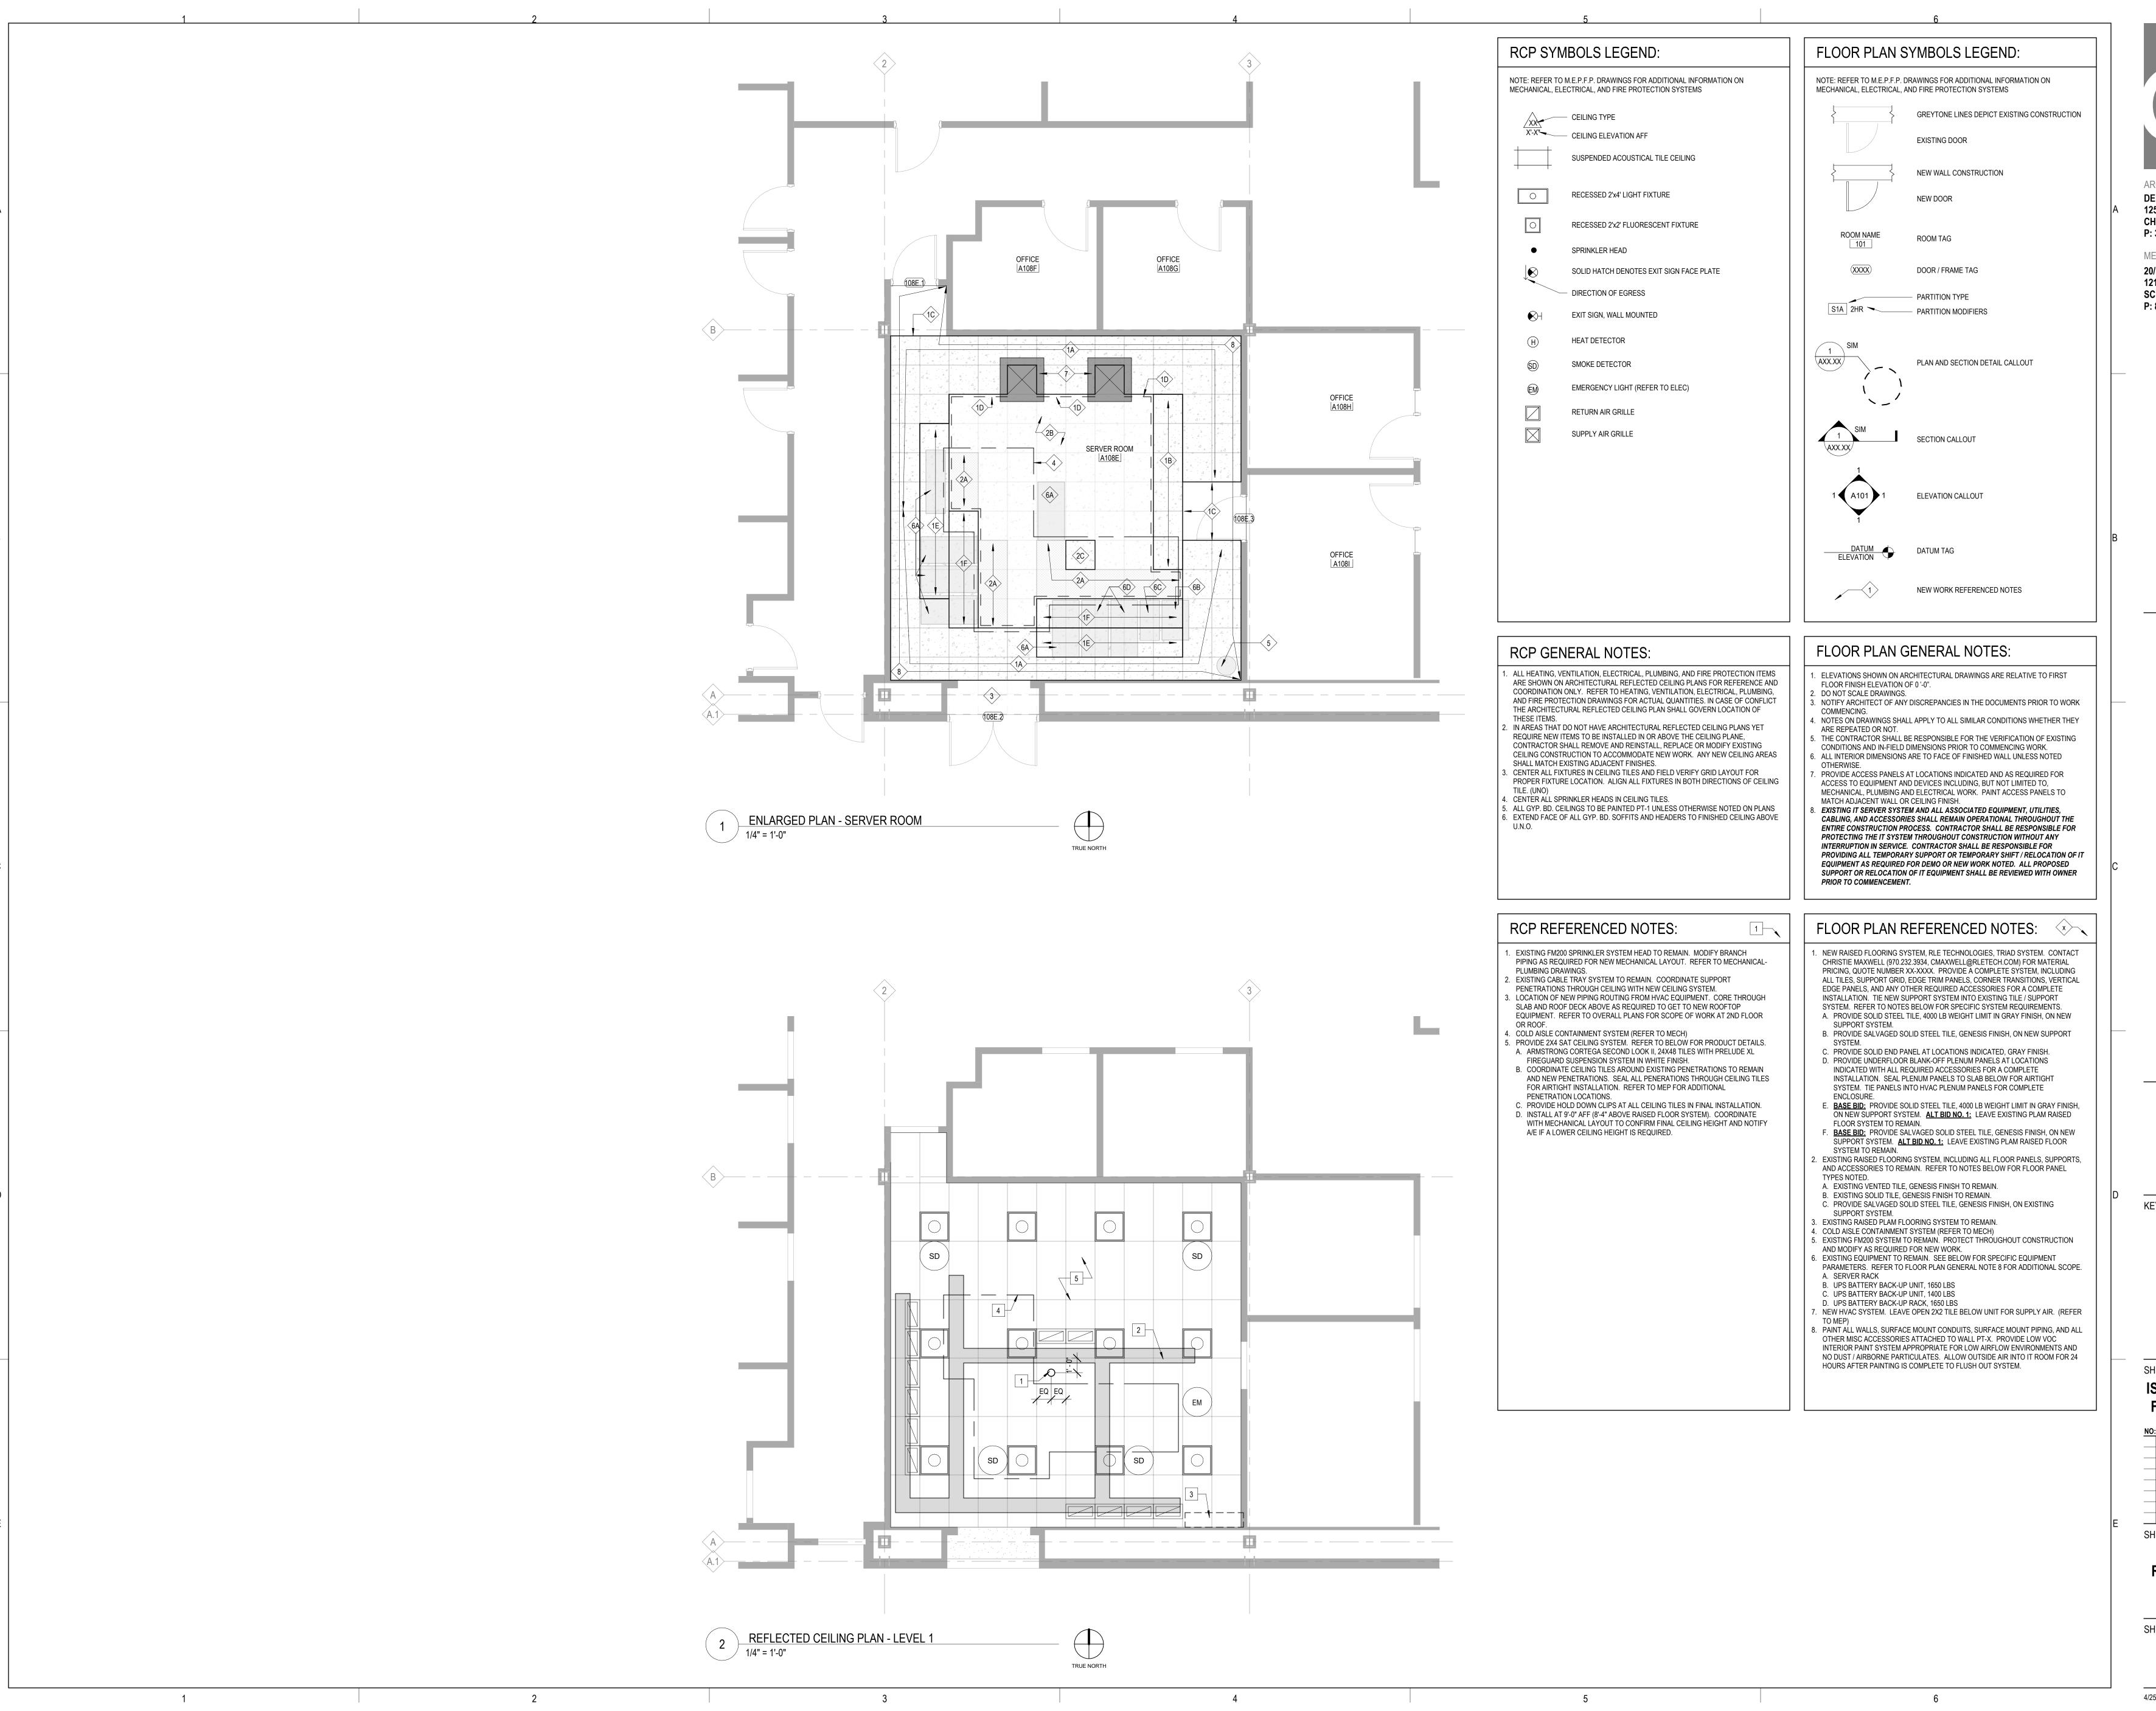
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OVERALL PLANS, DEMO PLAN, AND DEMO RCP

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MEP-FP ENGINEER 20/10 ENGINEERING GROUP, LLC **1216 TOWER ROAD** SCHAUMBURG, IL 60173 P: 847.882.2010

KEY PLAN:
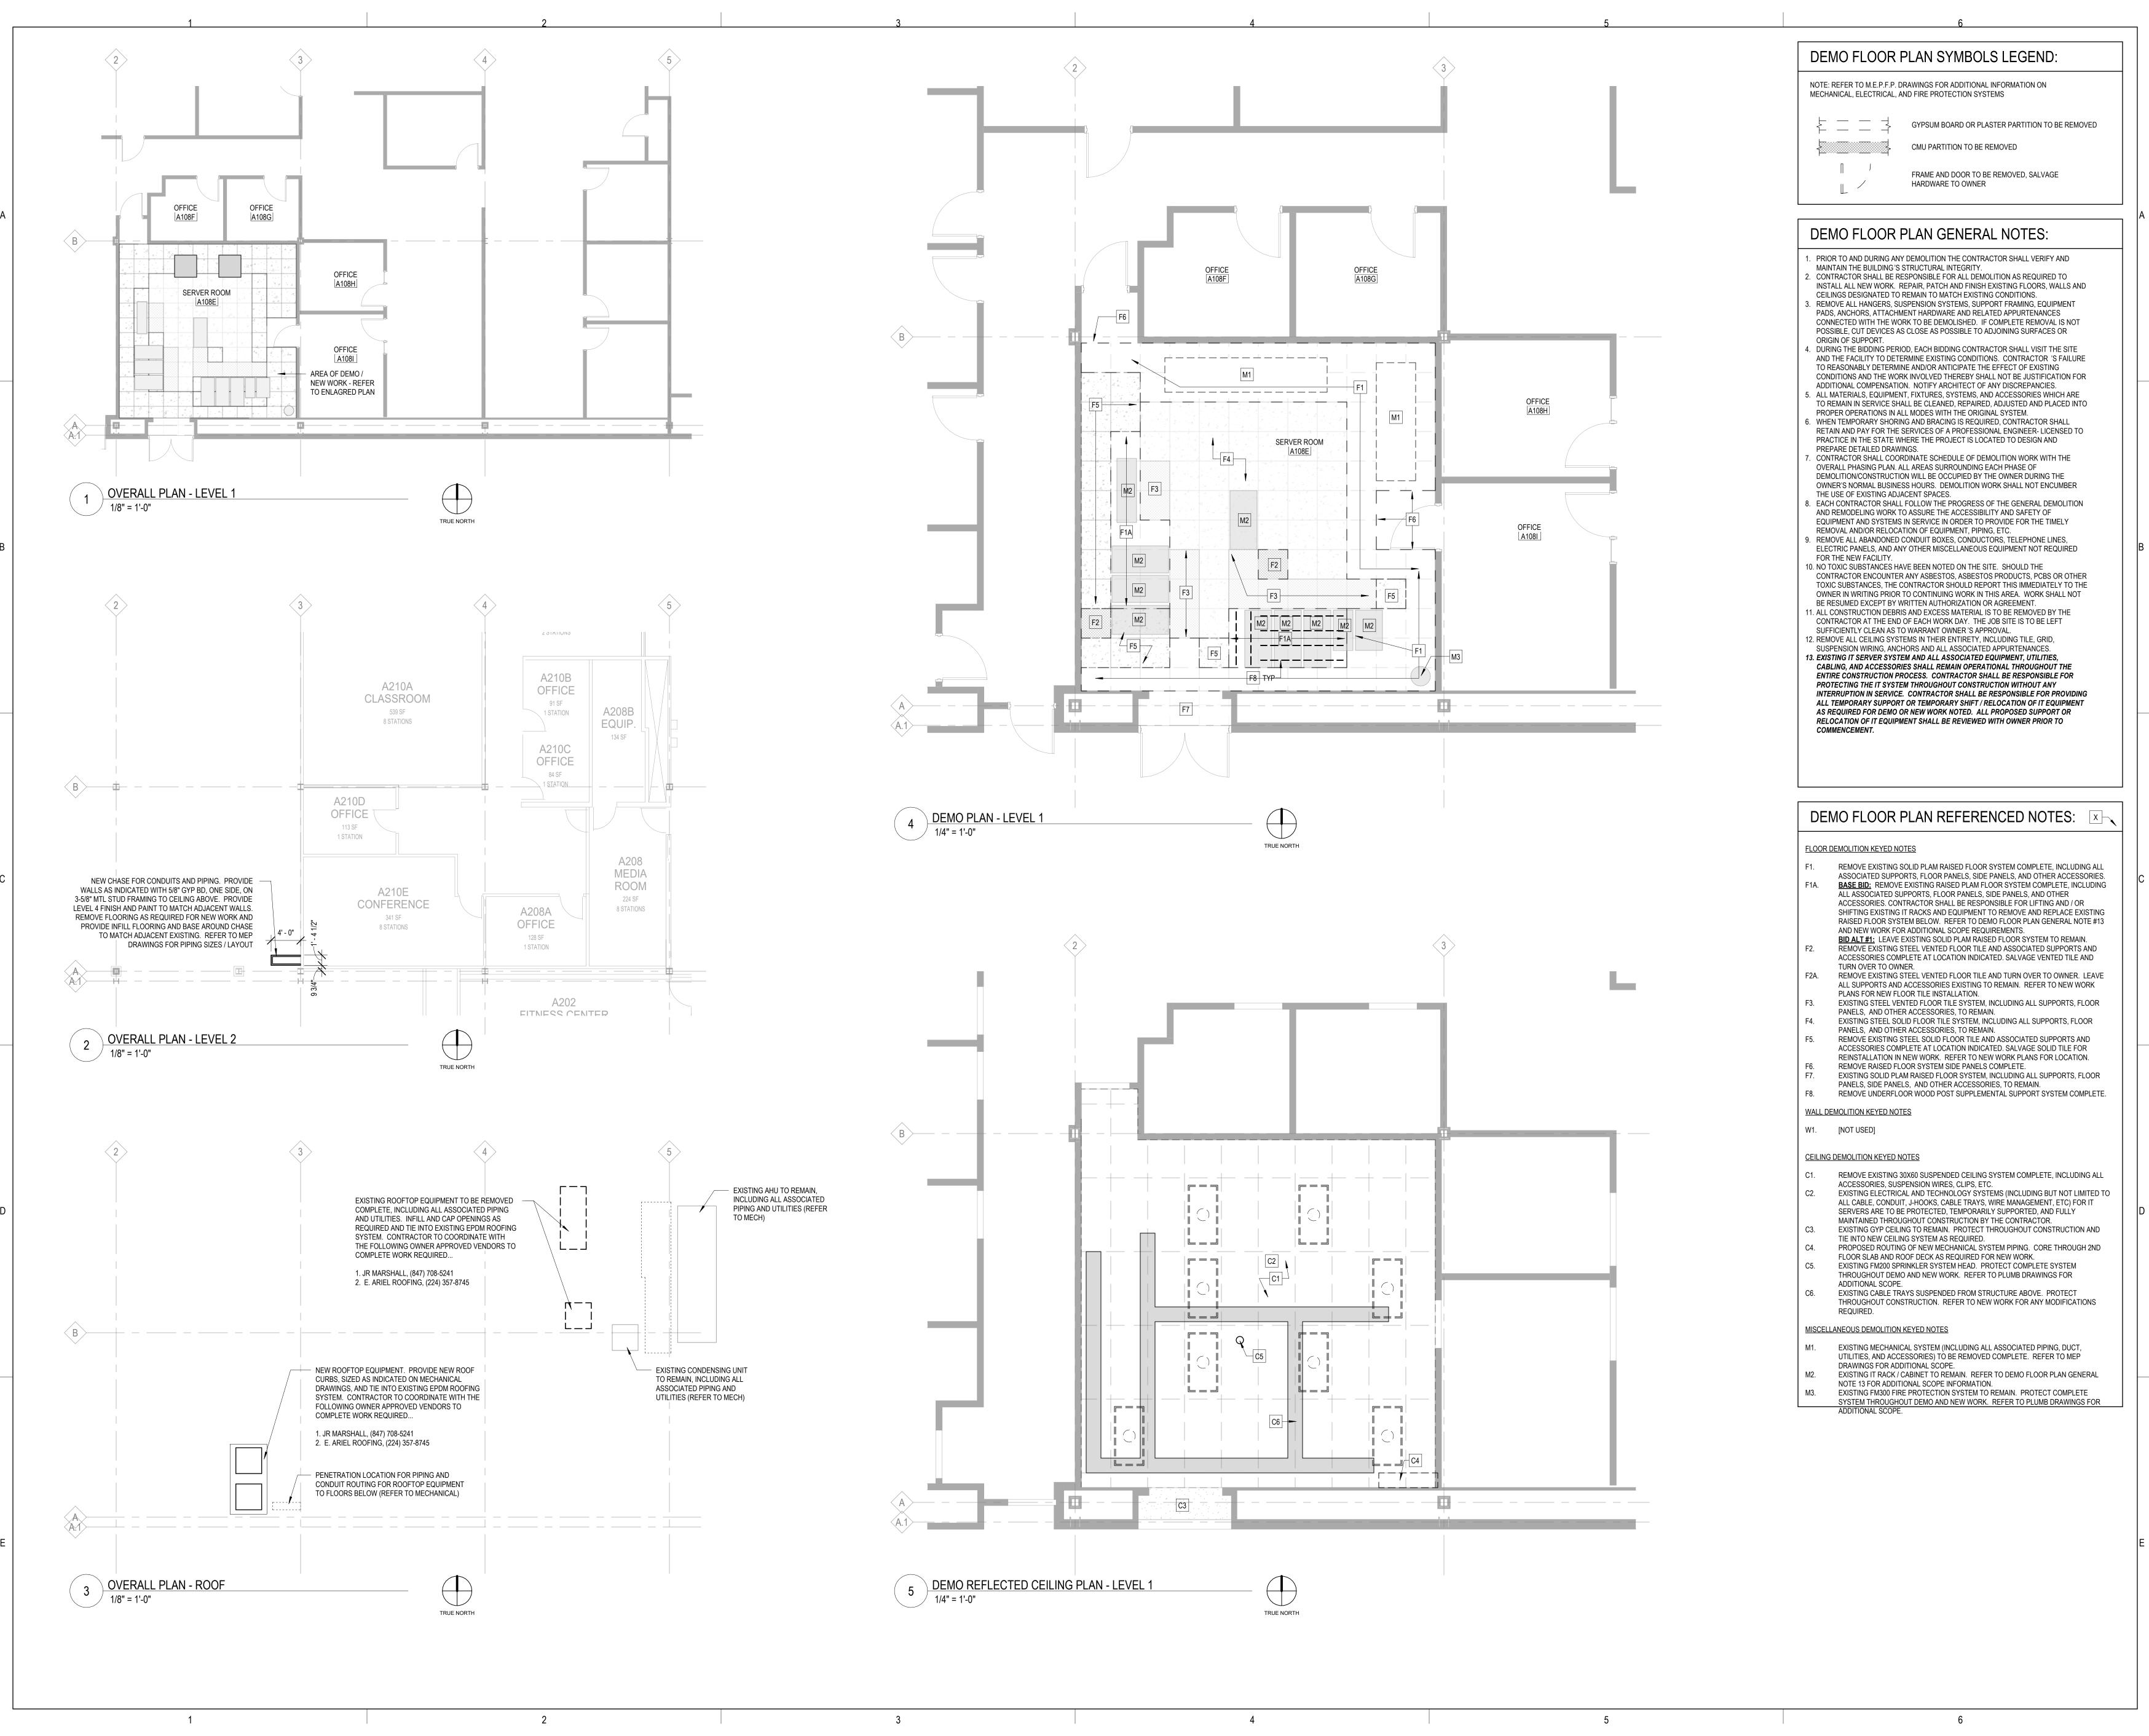
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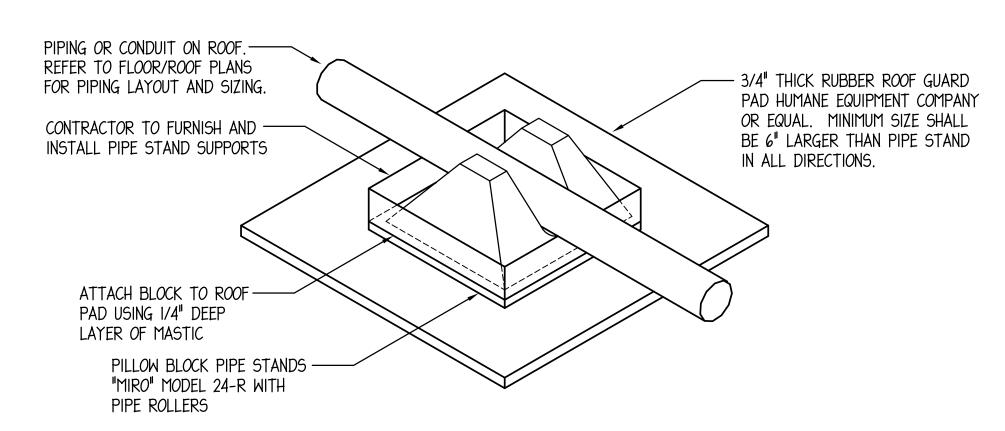
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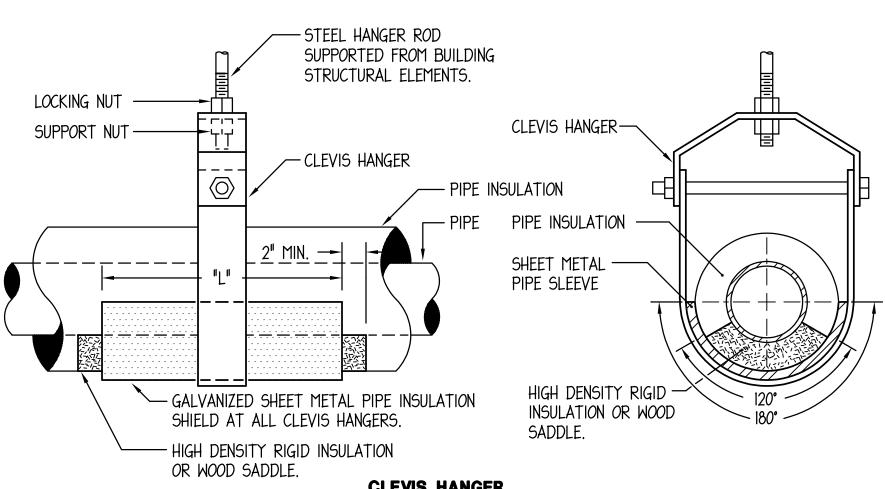
FLOOR PLAN AND REFLECTED CEILING **PLAN**

SHEET NUMBER:

4/25/2024 2:40:20 PM



PIPING OR CONDUIT ROOF SUPPORT DETAIL



 CLEVIS HANGER

 PIPE INSULATION SHIELD SCHEDULE

 PIPE SIZE
 LENGTH
 GAUGE

 UP TO 3/4"
 8"
 20 GA.

 1" - 2"
 12"
 18 GA.

 2 1/2" - 4"
 12"
 16 GA.

NOTE: I. CONFER WITH ARCHITECT AND REFER TO STRUCTURAL DRAWINGS FOR ADDITIONAL INFORMATION ON ACCEPTABLE METHODS AND LOCATIONS FOR HANGER SUPPORTS.


TYPICAL PIPE HANGER DETAILS

NO SCALE

GENERAL REMODELING NOTES - ALL CONTRACTORS

- I. ALL WORK SHOWN ON DRAWINGS SHALL BE CONSIDERED NEW AND IN CONTRACT UNLESS SPECIFICALLY INDICATED OTHERWISE.
- 2. DRAWINGS ARE GENERALLY DIAGRAMMATIC. ROUTING OF PIPING, DUCTWORK, CONDUITS, RACEWAYS, ETC., AS SHOWN ON DRAWINGS, DOES NOT INTEND TO SHOW EVERY RISE, DROP, OFFSET, FITTING NOR EVERY STRUCTURAL ELEMENT THAT MAY BE ENCOUNTERED DURING THE INSTALLATION OF THIS WORK. EACH CONTRACTOR SHALL MAKE ANY REQUIRED CHANGES FROM THE GENERAL ROUTING SHOWN ON THESE DRAWINGS, SUCH AS OFFSETS, BENDS OR CHANGES IN ELEVATION DUE TO COORDINATION WITH THE WORK OF OTHER TRADES AND BUILDING CONSTRUCTION. ALL CHANGES SHALL BE MADE WITHOUT ADDITIONAL COST TO THE OWNER OR DELAY IN COMPLETION DATE OF THE PROJECT.
- 3. IT IS INTENDED THAT EQUIPMENT SHALL BE LOCATED SYMMETRICALLY WITH THE ARCHITECTURAL ELEMENTS OF THE BUILDING, NOTWITHSTANDING THE FACT THAT LOCATIONS INDICATED BY THESE DRAWINGS MAY BE DISTORTED FOR CLEARNESS OF PRESENTATION.
- 4. CONTRACTOR SHALL CHECK DRAWINGS OF OTHER TRADES TO VERIFY THAT SPACES IN WHICH THEIR WORK WILL BE INSTALLED ARE CLEAR OF OBSTRUCTIONS. WORK SHALL BE INSTALLED TO MAINTAIN MAXIMUM HEADROOM AND SPACE CONDITIONS AT ALL POINTS IN THE BUILDING. WHERE HEADROOM OR SPACE CONDITIONS APPEAR INADEQUATE, CONTRACTOR SHALL NOTIFY OWNER/ARCHITECT/ENGINEER BEFORE PROCEEDING WITH THE INSTALLATION OF THEIR WORK.
- 5. CONTRACTOR SHALL FURNISH OTHER TRADES ADVANCE INFORMATION AND/OR SHOP DRAWINGS ON LOCATIONS AND SIZES OF PIPING, DUCTWORK, CONDUIT, RACEWAYS, EQUIPMENT, FRAMES, BOXES, SLEEVES AND OPENINGS, ETC. NEEDED FOR THEIR WORK TO PERMIT OTHER TRADES AFFECTED TO INSTALL THEIR WORK PROPERLY AND WITHOUT DELAY.
- WHERE THERE IS EVIDENCE THAT WORK OF ONE TRADE WILL INTERFERE WITH WORK OF OTHER TRADES, ALL TRADES SHALL MEET ON JOB SITE TO WORK OUT SPACE CONDITIONS AND MAKE SATISFACTORY ADJUSTMENTS TO INSTALLATION OF THE NEW WORK. CONTRACTORS SHALL VERIFY EXACT LOCATIONS OF ALL DEVICES AND EQUIPMENT WITH FIELD CONDITIONS, SHOP DRAWINGS, AND WORK OF OTHER TRADES PRIOR TO ROUGH-IN. EACH CONTRACTOR SHALL BE RESPONSIBLE, AT THEIR OWN EXPENSE, FOR THE REMOVAL AND REINSTALLATION OF ANY PART OF THEIR WORK IF SAME WAS INSTALLED WITHOUT CONSULTING WITH OTHER TRADES BEFORE INSTALLING THEIR WORK.
- 7. CONTRACTOR SHALL PROVIDE SLEEVES IN BEAMS, FLOORS, COLUMNS AND WALLS AS SHOWN ON THE DRAWINGS, AS REQUIRED BY JOB SITE CONDITIONS, AND/OR AS SPECIFIED, WHEN INSTALLING THEIR WORK. ALL BEAMS AND COLUMNS WHICH ARE REQUIRED TO BE SLEEVED SHALL BE CUT AND REINFORCED AS REQUIRED BY FIELD CONDITIONS AND LOCATIONS AND SIZES SHALL BE CHECKED AND APPROVED BY ARCHITECT BEFORE CONTRACTOR CUTS ANY STRUCTURAL BUILDING MEMBER.
- 8. THE SEQUENCE FOR THE INSTALLATION OF ALL WORK SHALL BE COORDINATED BETWEEN ALL CONTRACTORS ON THE PROJECT AND IN STRICT ACCORDANCE WITH ARCHITECT/ENGINEER AND OWNERS STIPULATION AS DIRECTED.
- 9. CONTRACTOR SHALL REFER TO THE ARCHITECTURAL AND STRUCTURAL CONTRACT DRAWINGS (BEFORE SUBMITTING THEIR BIDS) TO FAMILIARIZE THEMSELVES WITH THE EXTENT OF THE GENERAL CONTRACTOR'S WORK, CEILING HEIGHTS AND CLEARANCE FOR INSTALLING THEIR WORK
- 10. CONTRACTOR SHALL BE RESPONSIBLE AND PAY FOR ALL CORING, CUTTING, PATCHING, REPAIRING, REFINISHING AND REMOVAL/REPLACEMENT OF NEW OR EXISTING BUILDING CONSTRUCTION REQUIRED TO ACCOMMODATE THE INSTALLATION OR REMOVAL OF THEIR WORK. ALL PATCHING, REPAIRING AND REFINISHING WORK SHALL BE PERFORMED BY THOSE REGULARLY INVOLVED IN THAT TRADE AND SHALL MATCH THE ADJACENT CONSTRUCTION AS CLOSELY AS POSSIBLE. CARE SHALL BE TAKEN SO AS NOT TO DAMAGE ANY EXISTING BUILDING CONSTRUCTION OR ITEMS THAT ARE TO REMAIN. ANY EXISTING FINISHES THAT ARE DAMAGED DURING THE INSTALLATION OF NEW WORK OR REMOVAL OF EXISTING WORK SHALL BE REPAIRED, REPLACED AND PAID FOR BY THE INSTALLING CONTRACTOR, TO THE SATISFACTION OF THE ARCHITECT AND OWNER. REFER TO ARCHITECTURAL DRAWINGS FOR EXISTING BUILDING CONSTRUCTION THAT IS TO REMAIN AND, THEREFORE, SUBJECT TO PATCHING, REPAIRING, REFINISHING, AND REMOVAL/REPLACEMENT. (NOTE: CONTRACTOR SHALL VERIFY EXISTING BUILDING'S ROOF WARRANTY AND EMPLOY OTHER SUBCONTRACTOR(S) AS REQUIRED BY ROOF MANUFACTURER'S REPRESENTATIVE SO AS NOT TO VOID OWNER'S ROOF WARRANTY.)
- II. SOME OF THE EXISTING ITEMS AND EQUIPMENT SCHEDULED TO BE REMOVED SHALL BE TURNED OVER TO THE OWNER. ANY ITEMS THAT THE OWNER WANTS TO RETAIN SHALL BE REMOVED CAREFULLY SO AS NOT TO DAMAGE THEM. ALL OTHER ITEMS TO BE REMOVED SHALL BECOME THE PROPERTY OF THE CONTRACTOR AND REMOVED FROM THE SITE.
- 12. CONTRACTOR SHALL BE RESPONSIBLE FOR THEIR OWN CLEAN-UP DURING CONSTRUCTION. IF CONTRACTOR FAILS TO PROVIDE SUCH CLEAN-UP, THE ARCHITECT/ENGINEER WILL DIRECT ANOTHER CONTRACTOR TO PERFORM THE CLEAN-UP AND THE NEGLIGENT CONTRACTOR SHALL PAY THE ASSOCIATED BACK-CHARGES AS DEEMED APPROPRIATE BY THE ARCHITECT/ENGINEER.
- 13. CONTRACTOR SHALL INSTALL ALL AUXILIARY SUPPORTING STEEL AS REQUIRED FOR THE SUPPORTING OF THEIR PIPING, DUCTWORK, CONDUIT, TANKS, EQUIPMENT, ETC. ALL SUPPORTING STEEL FOR ITEMS ABOVE A SUSPENDED CEILING SHALL BE FROM BUILDING STRUCTURAL MEMBERS ONLY.
- IT IS MANDATORY THAT THE COMPLETE EXISTING BUILDING REMAIN IN CONTINUOUS AND NON-INTERRUPTED OPERATION DURING REMODELING/ALTERING OF SAID EXISTING BUILDING. THE SPECIFIC AREA(S) BEING REMODELED/ALTERED AT ANY SCHEDULED TIME ARE OBVIOUSLY EXCLUSIVE OF THIS STATEMENT. SERVICES TO EXISTING BUILDING SHALL BE KEPT IN CONTINUOUS OPERATION INCLUDING POWER, SIGNAL SYSTEMS, LIGHTING, TELEPHONE, HEATING, COOLING, VENTILATING, TEMPERATURE CONTROL, SEWERS AND HOT AND COLD WATER. ANY ABSOLUTELY NECESSARY INTERRUPTION OF THESE SERVICES TO ACCOMPLISH CONTRACT WORK SHALL BE ARRANGED WITH THE OWNER A MINIMUM OF TEN (10) WORKING DAYS IN ADVANCE. SUCH INTERRUPTIONS SHALL BE KEPT TO AN ABSOLUTE MINIMUM AS FAR AS TIME INTERVAL IS INVOLVED AND TEMPORARY SERVICES SHALL BE FURNISHED AND INSTALLED UNDER THIS CONTRACT WHERE NECESSARY TO ACCOMPLISH THIS PURPOSE. TEMPORARIES SHALL BE REMOVED BY THE CONTRACTOR ONLY AFTER NEW PERMANENT SERVICES ARE INSTALLED AND FULLY OPERATIONAL.

- IS. UNLESS INDICATED OTHERWISE, THE ARCHITECT/ENGINEER MAKES NO REPRESENTATION AS TO WHETHER OR NOT ANY HAZARDOUS OR CONTAMINATED MATERIALS (INCLUDING BUT NOT LIMITED TO ASBESTOS, PCB'S, CONTAMINATED SOILS, ETC.) ARE PRESENT WITHIN THE EXISTING BUILDING OR ON THE SITE. WORK SHOWN ON THE DRAWINGS AND/OR INDICATED IN THE SPECIFICATIONS SHALL NOT BE CONSTRUED TO CALL FOR CONTACT WITH ANY OF THESE MATERIALS. IF THESE MATERIALS ARE ENCOUNTERED OR SUSPECTED, THE CONTRACTOR SHALL NOT DISTURB THEM AND SHALL CONTACT THE ARCHITECT/ENGINEER IMMEDIATELY.
- 16. WHERE WORK CALLED FOR ON THE DRAWINGS OR IN THE SPECIFICATIONS INVOLVES THE REMOVAL OR RELOCATION OF PIPING OR EQUIPMENT CONTAINING REFRIGERANT, ALL REFRIGERANT SHALL BE RECOVERED BY APPROVED METHODS PER EPA REGULATIONS.
- 17. CONTRACTOR SHALL STORE ALL MATERIALS AND EQUIPMENT SHIPPED TO THE SITE IN A PROTECTED AREA. IF MATERIAL IS STORED OUTSIDE OF THE BUILDING, IT MUST BE STORED OFF THE GROUND A MINIMUM OF SIX INCHES (6") SET ON 6 X 6 PLANKS AND/OR WOOD PALLETS. ALL MATERIAL AND EQUIPMENT MUST BE COMPLETELY COVERED WITH WATERPROOF TARPS OR VISQUIN. ALL PIPING AND DUCTWORK WILL HAVE THE ENDS CLOSED TO KEEP OUT DIRT AND OTHER DEBRIS. NO EQUIPMENT WILL BE ALLOWED TO BE STORED OUTSIDE THE BUILDING ON THE SITE UNLESS IT IS SUPPORTED OFF THE GROUND AND COMPLETELY PROTECTED WITH WEATHERPROOF COVERS.
- 18. THE DRAWINGS, SCHEDULES AND SPECIFICATIONS HAVE BEEN PREPARED USING ONE MANUFACTURER FOR EACH PIECE OF EQUIPMENT AS THE BASIS FOR DIMENSIONAL DESIGN. IF THE CONTRACTOR PURCHASES EQUIPMENT FROM A SPECIFIED ACCEPTABLE MANUFACTURER, BUT NOT THE SCHEDULED MANUFACTURER USED FOR THE BASE DESIGN, THE CONTRACTOR SHALL BE RESPONSIBLE FOR CHECKING ALL THE DIMENSIONS OF THE EQUIPMENT TO VERIFY THAT IT WILL FIT IN THE SPACE SHOWN ON THE DRAWINGS. MINOR DEVIATIONS IN DIMENSIONS WILL BE PERMITTED, PROVIDED THE RATINGS MEET THOSE SHOWN ON THE DRAWINGS AND EQUIPMENT WILL PHYSICALLY FIT INTO THE SPACE ALLOCATED WITH SUITABLE ACCESS AROUND EQUIPMENT FOR OPERATION AND MAINTENANCE OF THE EQUIPMENT. WHEN EQUIPMENT SUBMITTED FOR REVIEW DOES NOT MEET THE PHYSICAL SIZE OR ARRANGEMENT OF THAT SCHEDULED AND SPECIFIED, CONTRACTOR SHALL PAY FOR ALL ALTERATIONS REQUIRED TO ACCOMMODATE SUCH EQUIPMENT AT NO ADDITIONAL COST TO THE OWNER. CONTRACTOR WILL ALSO PAY ALL COSTS FOR ADDITIONAL WORK REQUIRED BY OTHER CONTRACTORS, OWNER, ARCHITECT OR ENGINEER TO MAKE CHANGES WHICH WOULD ALLOW THE EQUIPMENT TO FIT IN THE SPACE AND FUNCTION AS INTENDED.
- 19. CONTRACTOR AND/OR MANUFACTURER SHALL VERIFY THAT THE CHARACTERISTICS OF THE EQUIPMENT SUBMITTED FOR REVIEW MEETS THE CAPACITY AND DUTY SPECIFIED. WHEN EQUIPMENT SUBMITTED FOR REVIEW REQUIRES MODIFICATIONS TO THE WORK OF OTHER CONTRACTORS, SUBMITTING CONTRACTOR SHALL PAY FOR ALL COSTS FOR ADDITIONAL WORK REQUIRED BY OTHER CONTRACTORS, OWNER, ARCHITECT OR ENGINEER TO MAKE CHANGES WHICH WOULD ALLOW THE EQUIPMENT FUNCTION SAFELY AND PROPERLY.
- 20. CONTRACTOR SHALL FIELD VERIFY THE SIZE OF EXISTING OPENINGS, WINDOWS, DOORS, CORRIDORS, ROOMS, ETC. FOR ACCESS OF THE NEW EQUIPMENT INTO OR REMOVAL OF EXISTING EQUIPMENT FROM THE BUILDING. IF OPENINGS ARE TOO SMALL FOR ACCESS THEN CONTRACTOR SHALL, AT THEIR OWN EXPENSE, PROVIDE NEW OR ENLARGED OPENINGS AND RESTORE SAME TO ORIGINAL SIZE AND CONDITION. CONTRACTOR MAY ELECT TO ORDER THE EQUIPMENT DISASSEMBLED AND/OR WITH SPLIT HOUSING FOR ENTRANCE INTO THE EXISTING SPACE OR BUILDING. CONTRACTOR SHALL REASSEMBLE EQUIPMENT AFTER IT IS IN THE SPACE AT THEIR OWN EXPENSE.
- 21. CONTRACTOR SHALL BE RESPONSIBLE FOR OBTAINING ALL NECESSARY PERMITS AND THEIR ASSOCIATED FEES.
- 22. CONTRACTOR SHALL SUBMIT DIGITAL COPIES OF SHOP DRAWINGS OF ALL EQUIPMENT, DIFFUSERS, REGISTERS, TEMPERATURE CONTROL SYSTEM, FIRE DAMPERS, LIGHTING FIXTURES, PANELBOARDS, ELECTRICAL DEVICES, PLUMBING FIXTURES, AND 1/4" = 1'-0" SCALE DETAILED DUCT LAYOUT DRAWINGS TO ENGINEER FOR APPROVAL PRIOR TO ORDERING ANY ITEMS OR FABRICATING ANY DUCTWORK.
- 23. CONTRACTOR SHALL PROVIDE OWNER TRAINING ON ALL EQUIPMENT AND BUILDING SYSTEMS PROVIDED/ALTERED BY THEIR WORK. TRAINING SHALL BE ACCOMPLISHED DURING TIME DEDICATED FOR THAT PURPOSE, NOT IN CONJUNCTION WITH SERVICE WORK.
- 24. AT COMPLETION OF PROJECT, CONTRACTOR SHALL SUBMIT ONE PHYSICAL AND DIGITAL COPIES OF OPERATION AND MAINTENANCE MANUALS FOR ALL WORK PROVIDED BY THEM ON PROJECT. MANUALS SHALL BE CLEARLY ORGANIZED AND CONTAIN COPIES OF APPROVED EQUIPMENT, SHOP DRAWINGS, EQUIPMENT PARTS LISTS, SERVICE CONTACTS, CONTRACTOR AND MANUFACTURER WARRANTEES, AND "AS BUILT" FLOOR PLANS.
- 25. CONTRACTOR SHALL PROVIDE WARRANTY FOR ALL MATERIAL AND GUARANTEE ALL WORKMANSHIP PROVIDED BY THEM FOR I (ONE) YEAR FROM SUBSTANTIAL COMPLETION OF WORK INVOLVED.
- 26. CONTRACTOR SHALL MAINTAIN A CURRENT CRYSTAL LAKE LICENSE THROUGHOUT ALL PHASES OF CONSTRUCTION. IT SHALL BE THE CONTRACTORS RESPONSIBILITY TO COORDINATE ANY INSPECTIONS WITH CRYSTAL LAKE OFFICIALS. CONTRACTOR SHALL PROVIDE ANY MINIMUM PRIOR NOTICE FOR INSPECTIONS WITH OFFICIALS.
- 27. IDENTIFY ALL PIPING AND DUCTWORK WITH PLASTIC LABELS INDICATING CONTENTS AND FLOW DIRECTION. MARKERS TO BE PLACED AT A MAXIMUM OF 50 FT. INTERVALS AT BRANCH CONNECTIONS, AND AT BOTH SIDES OF WALL/FLOOR PENETRATIONS. IDENTIFY VALVES, EQUIPMENT, AND PANELS WITH ENGRAVED 3-LAYER PLASTIC LAMINATED TAGS OR SIGNS.

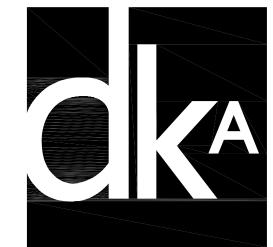

ARCHITECT OF RECORD

DEMONICA KEMPER ARCHITECTS

125 N. HALSTED STREET, SUITE 301

CHICAGO, IL 60661

P: 312.496.0000

MEP-FP ENGINEER
20/10 ENGINEERING GROUP, LLC
1216 TOWER ROAD
SCHAUMBURG, IL 60173
P: 847.882.2010

RY COUNTY COLLEGE VER ROOM IMPROVEMENTS

900 U.S. Highway 14 rystal Lake, IL 60012 KA PROJECT NO: 21-042

KEY PLAN:

SHEET STATUS: 04/25/2024

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FOR CONSTRUCTION


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MEP COORDINATION NOTES AND DETAILS

SHEET NUMBER:

1E1.00



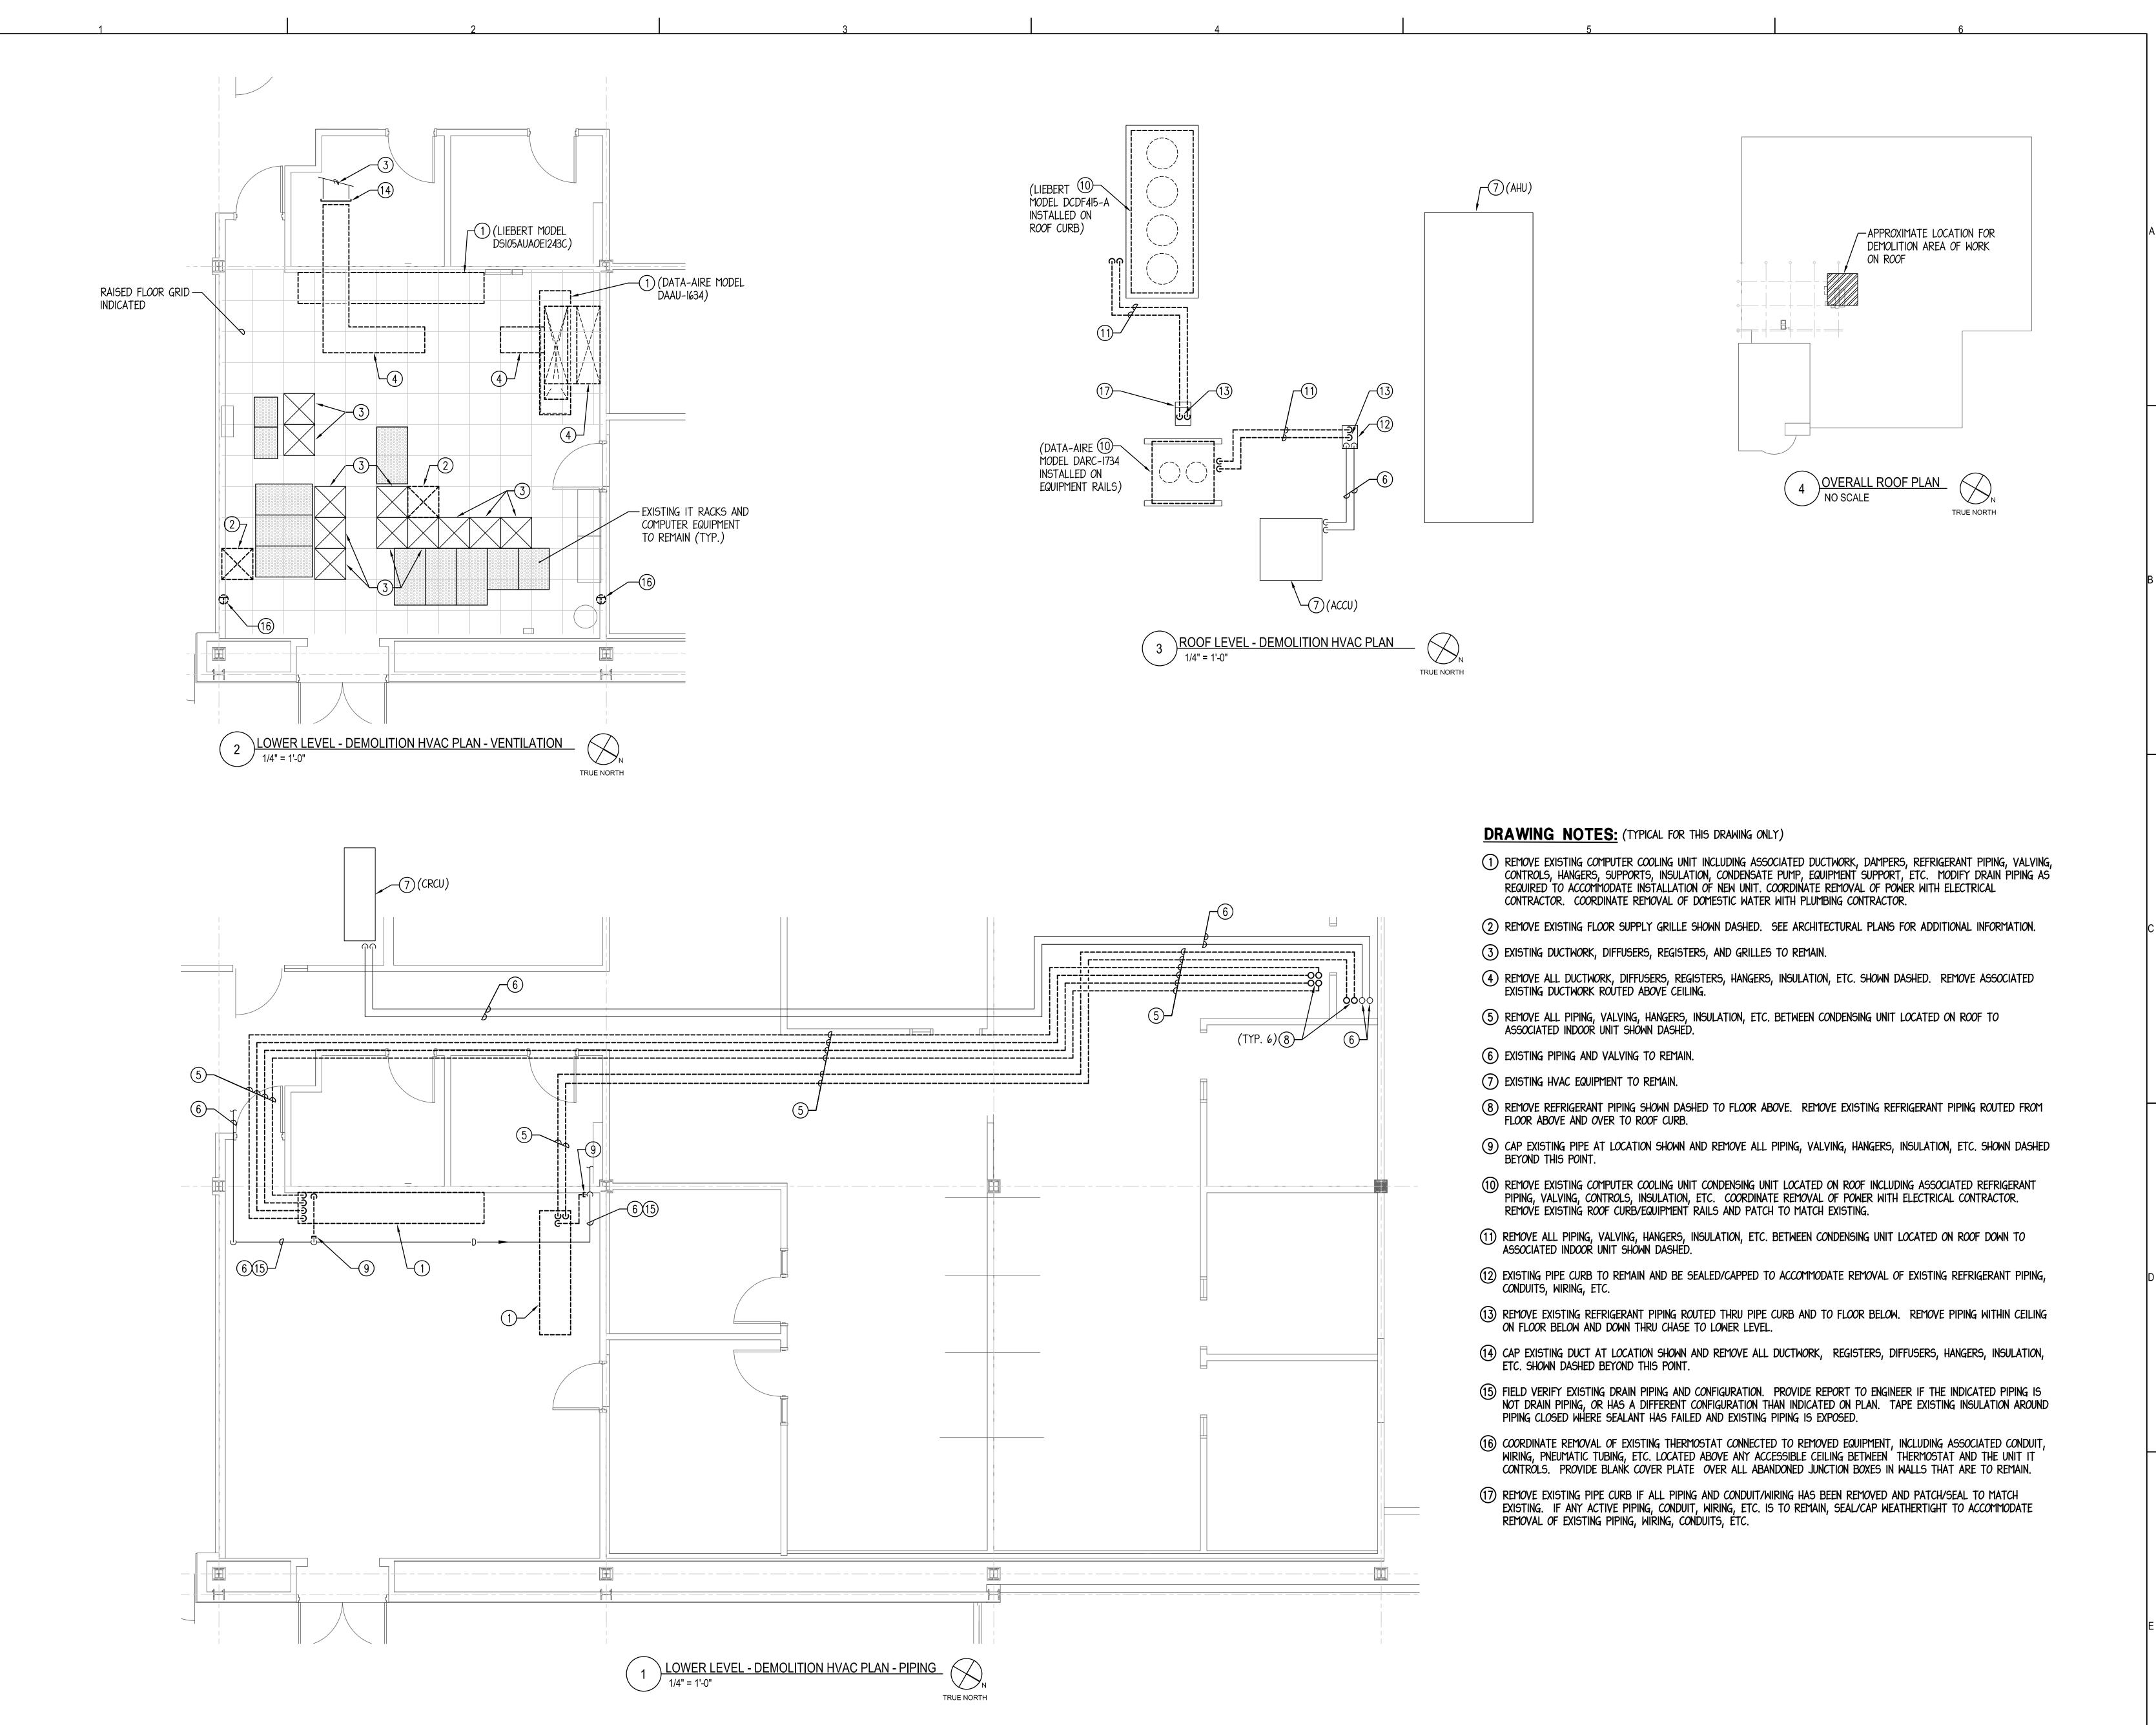

MEP-FP ENGINEER

20/10 ENGINEERING GROUP, LLC

1216 TOWER ROAD

SCHAUMBURG, IL 60173


P: 847.882.2010

COUNTY COLLEGI ROOM IMPROVEMENT

8900 U.S. Highway 14 Crystal Lake, IL 60012

KEY PLAN:


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FOR CONSTRUCTION

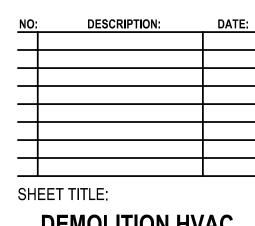



DEMOLITION HVAC PLANS


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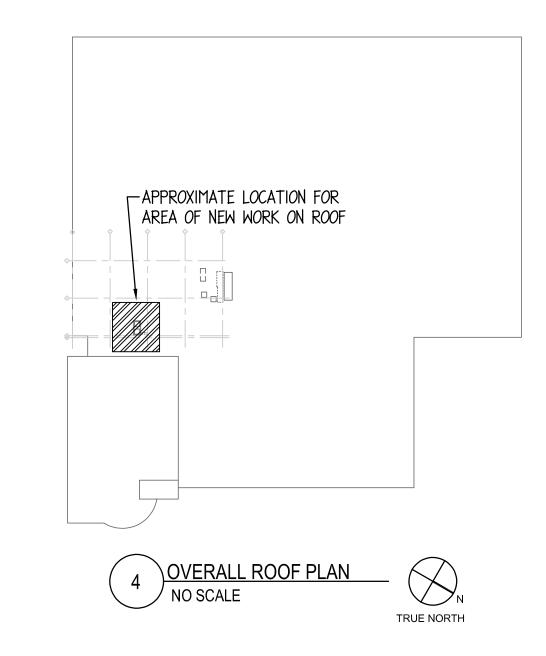
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DRAWING NOTES: (TYPICAL FOR THIS DRAWING ONLY)

- (1) COORDINATE SUPPLY OPENING AT BOTTOM OF UNIT TO LINE UP WITH NEW FLOORING OPENING TO SUPPLY PLENUM. COORDINATE MODIFICATIONS OF RAISED FLOOR AND SUPPORTS/PANELS AS REQUIRED TO ACCOMMODATE INSTALLATION OF NEW UNIT, INCLUDING UNDERFLOOR PLENUM PANELS FOR SUPPLY AIRFLOW PATH BENEATH UNIT. COORDINATE LOCATION OF DUCT SMOKE DETECTORS IN RETURN, TEMPERATURE SENSORS AND EQUIPMENT CONTROL PANELS WITH ALL TRADES. SEE ARCHITECTURAL PLANS FOR ADDITIONAL INFORMATION.
- 2 EXISTING FLOOR SUPPLY DIFFUSER TO REMAIN. BALANCE SUPPLY GRILLE TO 330 CFM WITH ONE CRCU OPERATING, AND 660 CFM WITH BOTH CRCU OPERATING.
- ROUTE REFRIGERANT SUCTION AND LIQUID PIPING AS INDICATED. COORDINATE PIPING SIZES, INSULATION, PITCH AND QUANTITY WITH MANUFACTURER'S RECOMMENDATIONS.
- (4) EXISTING PIPING AND VALVING TO REMAIN.
- (5) EXISTING HVAC EQUIPMENT TO REMAIN.
- 6 ROUTE REFRIGERANT PIPING UP TO WITHIN CHASE ON FLOOR ABOVE. SEE PLAN 6 THIS SHEET FOR CONTINUATION.
- OCLD AISLE CONTAINMENT SYSTEM SHOWN DASHED.
 PROVIDE AND INSTALL SUBZERO ENGINEERING ESSENTIAL SERIES RACK HAT WITH CLEAR VINYL CONTAINMENT SYSTEM (OR EQUIVALENT RLE TECHNOLOGIES (800-518-1519), OR EQUAL ONLY AS APPROVED BY ENGINEER). CONTAINMENT SYSTEM SHALL BE COMPLETE WITH ALL COMPONENTS INSTALLED PER MANUFACTURER'S RECOMMENDATIONS. TRACK KIT SHALL BE INSTALLED AT CEILING AND BE COMPLETE WITH MODULAR RAIL SYSTEM, CEILING CLIPS WITH 135°F FUSIBLE LINK, AND ATTACHED VINYL FIRE RATED CURTAIN CONTAINMENT SYSTEM.
 COORDINATE TRACK SYSTEM AND VINYL CURTAINS WITH ALL FIELD CONDITIONS INCLUDING EXISTING EQUIPMENT LOCATIONS AND DIMENSIONS, CABLES, CABLE TRAYS, CONDUITS, PERSONNEL OPENING LOCATIONS, ETC. PRIOR TO ORDERING.

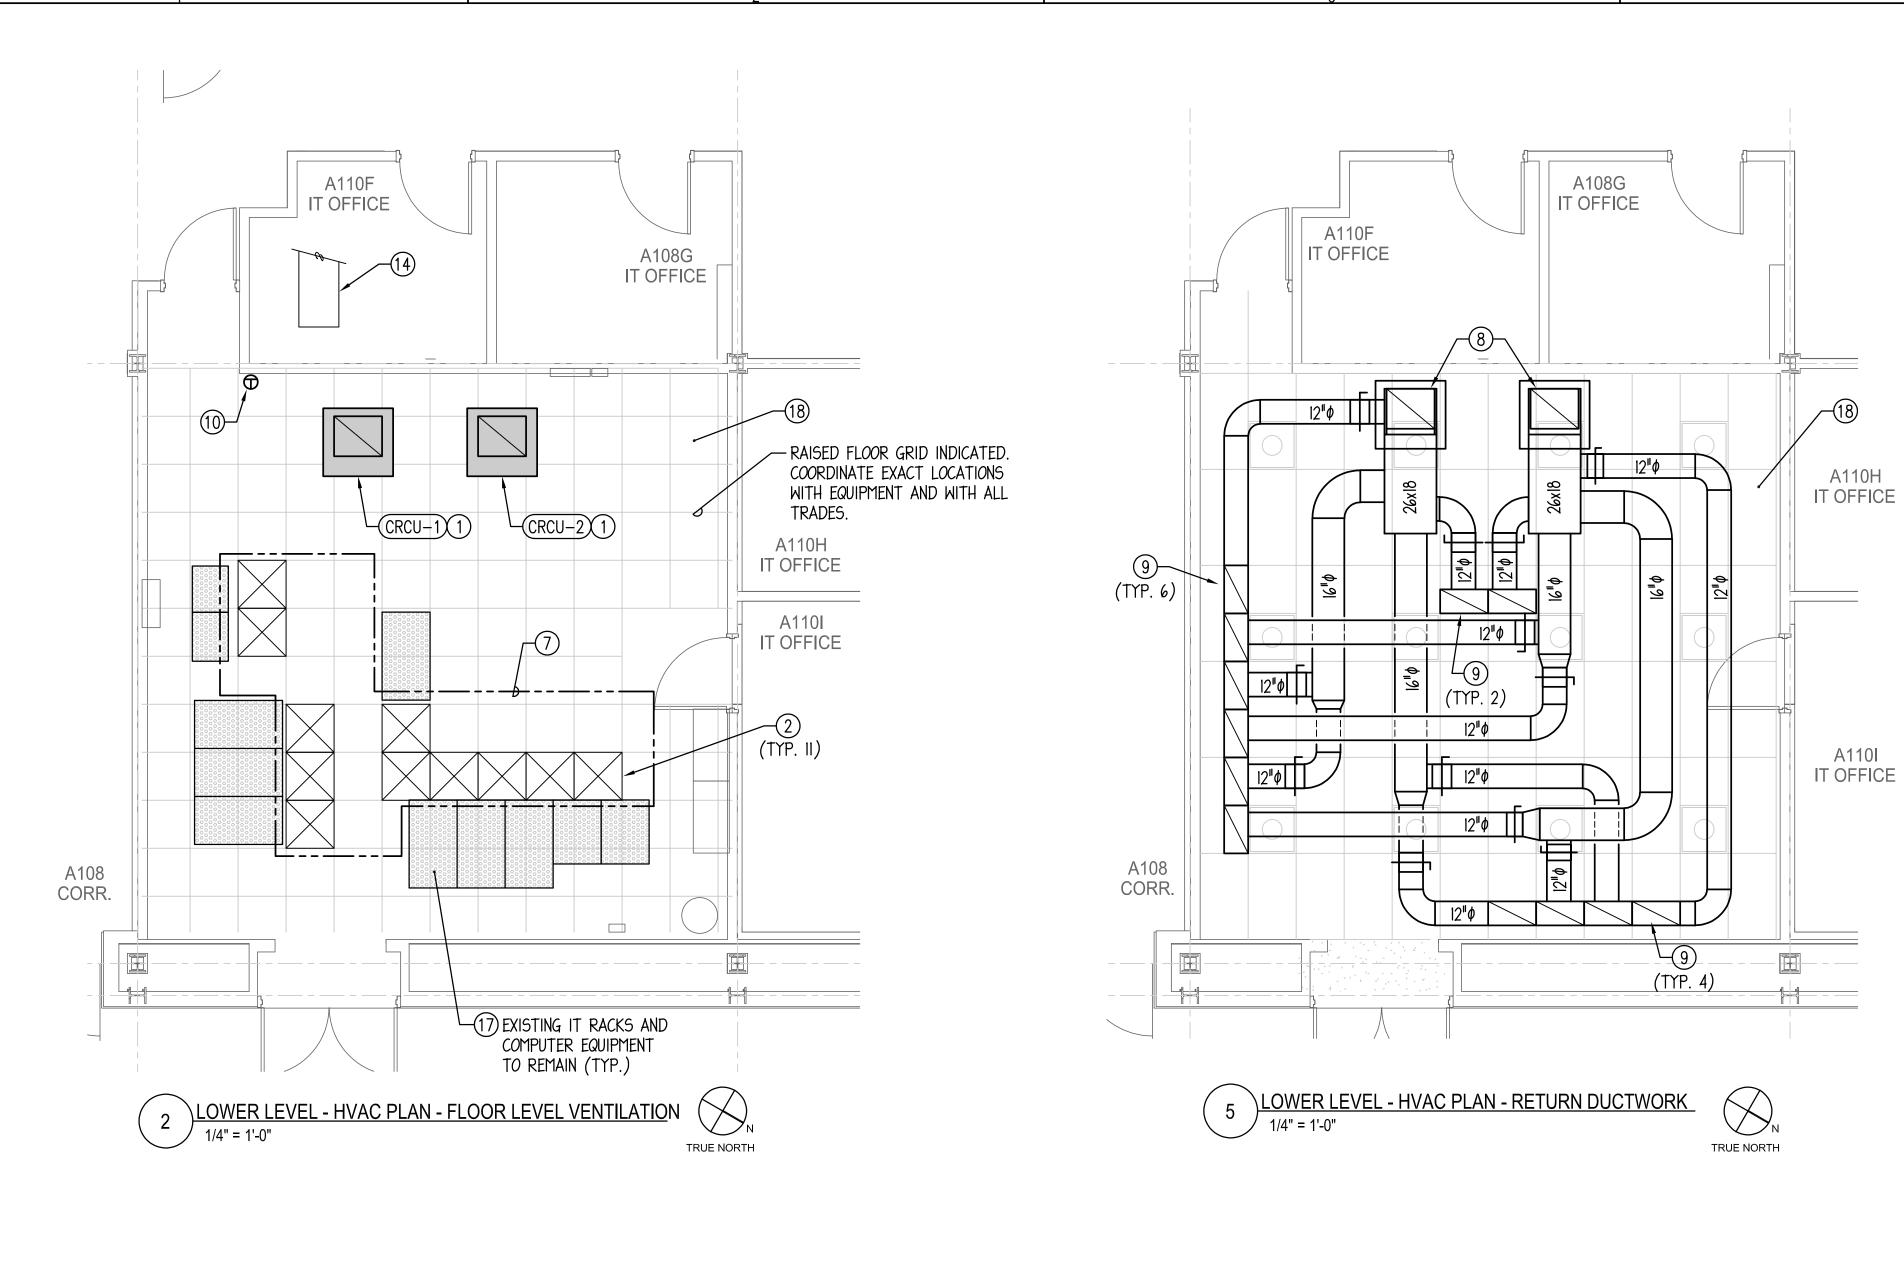VINYL SHEETS SHALL BE OVERLAPPED TO MAINTAIN PROPER AIR CONTAINMENT FOR THE COLD AISLE. EXCESS VINYL SHALL BE ROLLED UP AND CLIPPED FOR PROPER HANGING. VINYL SHALL BE MODIFIED TO WORK AROUND EXISTING EQUIPMENT, CABLING, CABLE TRAYS, CONDUITS, AND ANY OTHER FIELD CONDITIONS.

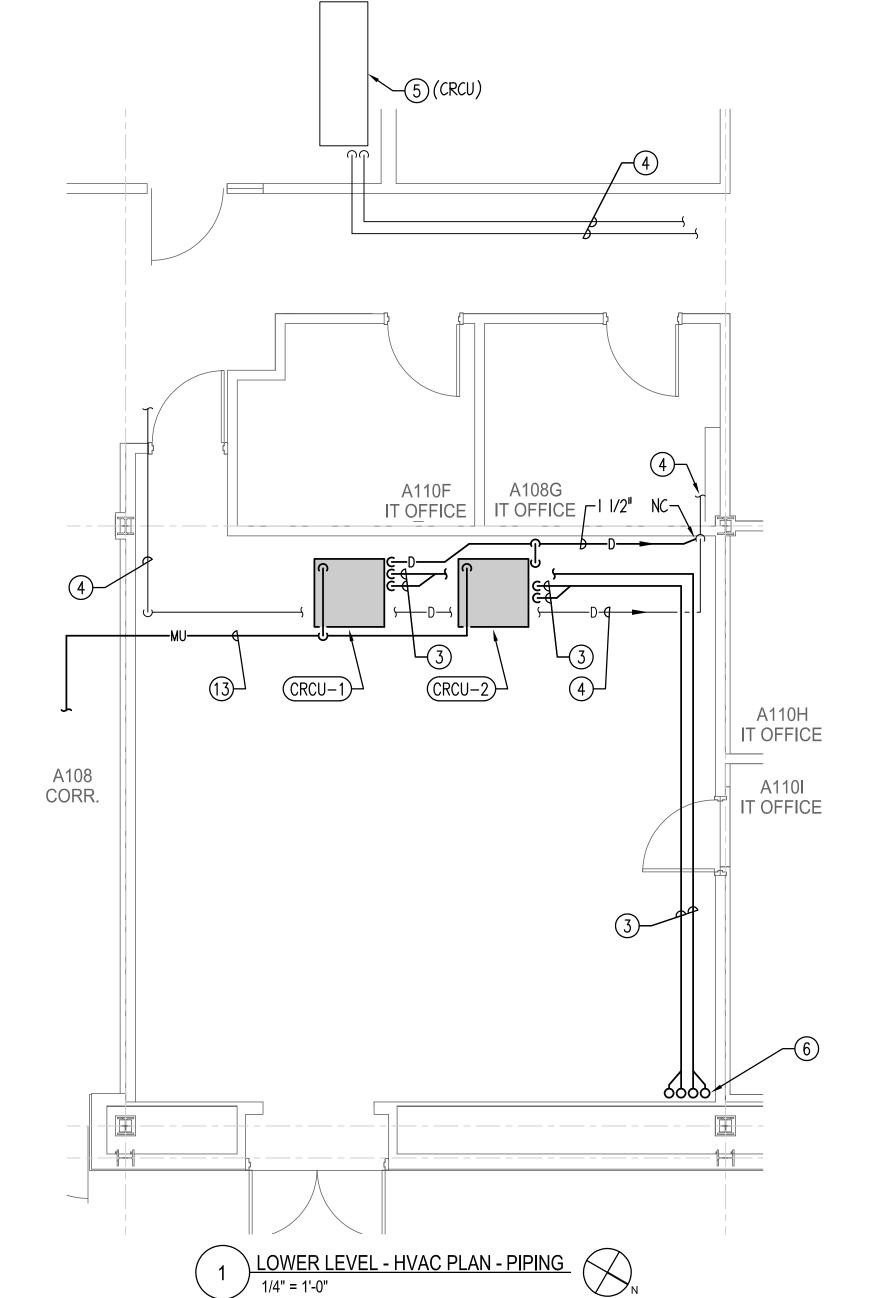VINYL SHEETS SHALL BE INSTALLED AROUND ANY OBSTRUCTIONS AND CUT/SEALED AS REQUIRED. VINYL BENEATH OBSTRUCTIONS SHALL BE RE-JOINED TOGETHER WITH TWO-SIDED TAPE OR VELCRO PER MANUFACTURERS INSTALLATION RECOMMENDATIONS. SPLICES SHALL BE LOCATED AS TO NOT OBSTRUCT MAINTENANCE OF LIGHT FIXTURES.

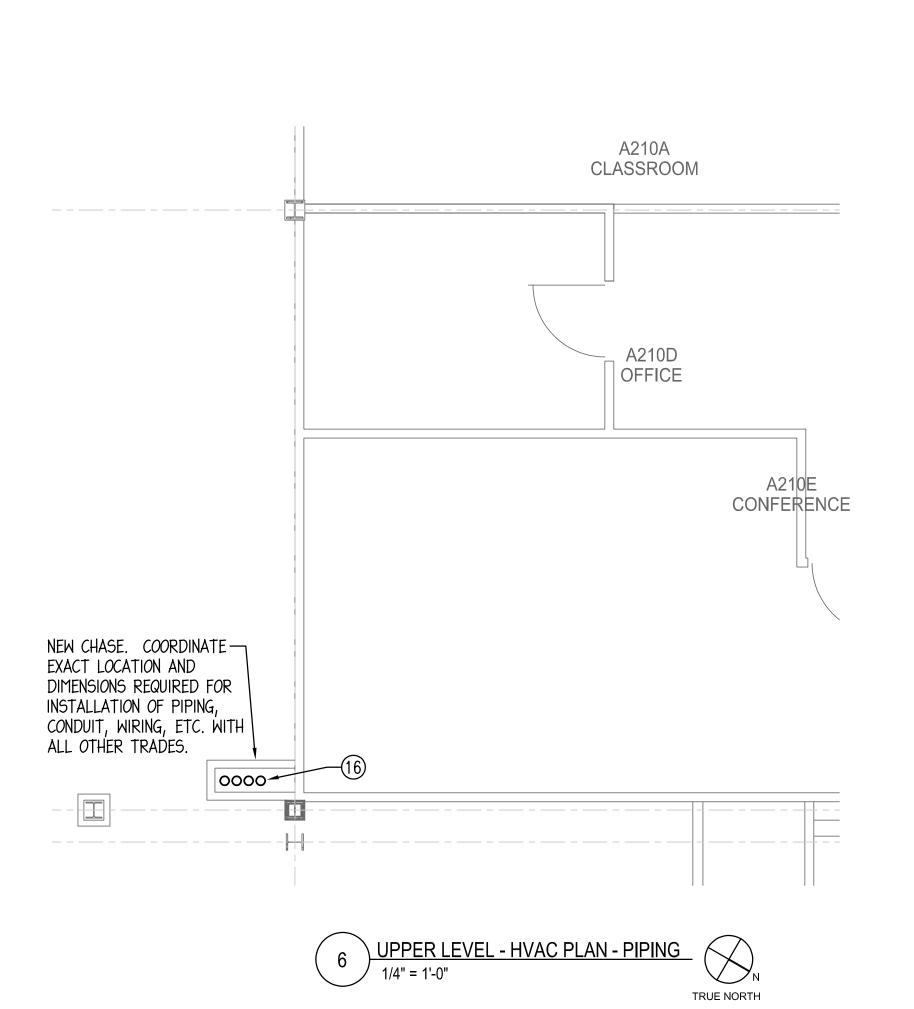COORDINATE LOCATION AND INSTALLATION OF VINYL CONTAINMENT SYSTEM WITH THE EXISTING FM200 FIRE SUPPRESSION SYSTEM. COORDINATE MODIFICATIONS INCLUDING RELOCATING AND ADDING FIRE PROTECTION HEADS AND SENSORS AS REQUIRED TO MAINTAIN PROPER OPERATION OF THE FIRE SUPPRESSION SYSTEM WITH ALL TRADES.

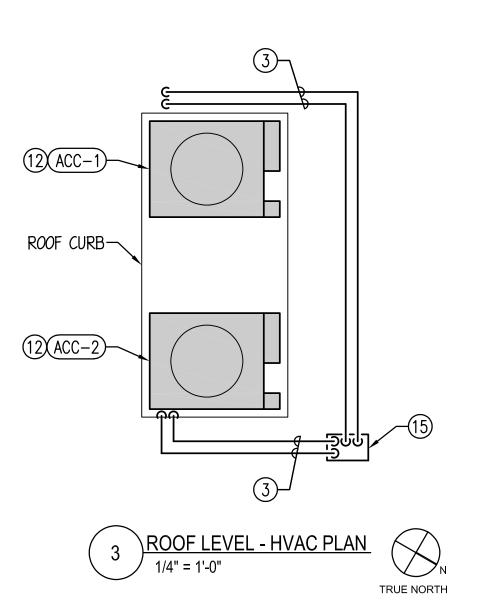- 8 LIEBERT FACTORY RETURN AIR PLENUM WITH FILTER RACK AND EXTENSION TO ABOVE CEILING. SEAL PLENUM AND ROUTE RETURN DUCTWORK CONNECTED ABOVE CEILING AS INDICATED. FIELD COORDINATE EXACT RETURN DUCTWORK LOCATIONS WITH ALL EXISTING FIELD CONDITIONS. COORDINATE INSTALLATION OF PLENUM AND FILTER RACK SO THAT FILTERS ARE EASILY ACCESSIBLE AND HAS TOOL-LESS ACCESS FOR FILTER REPLACEMENT.
- 9 NEW TITUS 50F EGGCRATE RELIEF GRILLE, 12"x24" LAY-IN FACE, 10"x22" NECK IN CEILING, LOCATED BEHIND SERVER RACKS/EQUIPMENT. BALANCE TO 600 CFM. FIELD COORDINATE EXACT LOCATION IN NEW CEILING, WITH EQUIPMENT, AND WITH ARCHITECT.
- NEW TEMPERATURE SENSOR TO BE TIED INTO EXISTING BAS SYSTEM. TEMPERATURE SYSTEM SHALL BE READ BY EXISTING BAS AND SHALL SEND AN ALARM WHENEVER TEMPERATURE IS ABOVE SETPOINT (ADJUSTABLE).
- 11) ROUTE REFRIGERANT PIPING, CONDUITS, WIRING, ETC. DOWN THRU NEW PIPE CURB AND OFFSET TO WITHIN CHASE ON FLOOR BELOW.
- (12) INSTALL NEW EQUIPMENT ON NEW ROOF CURB. EXTEND CURB TO BE MINIMUM 4" BEYOND EQUIPMENT FOOTPRINT. COORDINATE REQUIREMENTS AND WEIGHTS WITH ALL TRADES. MAINTAIN MANUFACTURER'S RECOMMENDED EQUIPMENT CLEARANCES.
- (13) ROUTE DOMESTIC WATER PIPING FROM PIPING SERVING HOSE BIBS (ADJACENT TO TOILET AREAS IN CORRIDOR LOCATED APPROXIMATELY 50' AWAY) TO NEW EQUIPMENT INDICATED. CONNECT TO EACH NEW MECHANICAL UNIT PER MANUFACTURER'S REQUIREMENTS. COORDINATE ROUTING AND REQUIREMENTS WITH ALL OTHER TRADES.
- (14) EXISTING DUCTWORK, DIFFUSERS, REGISTERS, AND GRILLES TO REMAIN.
- (15) NEW PIPE CURB ON ROOF. ROUTE NEW REFRIGERANT PIPING, CONDUIT, WIRING, ETC THRU NEW CURB. COORDINATE LOCATION WITH ALL OTHER TRADES.
- (16) ROUTE PIPING FROM FLOOR BELOW UP TO WITHIN CHASE. OFFSET PIPING WITHIN CEILING AREA AS REQUIRED TO ROUTE PIPING UP THRU PIPE CURB ON ROOF. SEE PLANS I AND 3 THIS SHEET FOR CONTINUATION.
- (7) COORDINATE WITH OWNER AND IT STAFF, ADDITION OF SUBZERO ENGINEERING (OR EQUIVALENT RLE TECHNOLOGIES, OR EQUAL ONLY AS APPROVED BY ENGINEER) BLANKING PANELS TO BE LOCATED WITHIN IN SERVER RACKS TO MAINTAIN PROPER AIR PATHWAYS. CONTRACTOR SHALL COORDINATE LOCATION, SIZES, COLOR AND QUANTITY OF PANELS AS REQUIRED. INSTALLATION OF PANELS WITHIN EXISTING SERVER RACKS SHALL BE COORDINATED WITH OWNER.
- (8) COORDINATE ALL WORK TO BE PERFORMED IN THIS AREA WITH THE EXISTING FM200 FIRE SUPPRESSION SYSTEM INCLUDING PIPING, SENSOR AND HEAD LOCATIONS. CONTACT PEDRO CLAVERO AT CINTAS CORPORATION (630-978-0600, CLAVEROP@CINTAS.COM) AND COORDINATE FIRE SUPPRESSION SYSTEM MODIFICATIONS INCLUDING REVISING SYSTEM FOR PIPING, HEAD, AND SENSOR REQUIREMENTS. COORDINATE RETURN GRILLE LOCATIONS AND COLD AISLE CONTAINMENT SYSTEM CURTAINS AND LOCATIONS.



ARCHITECT OF RECORD

DEMONICA KEMPER ARCHITECTS

125 N. HALSTED STREET, SUITE 301

CHICAGO, IL 60661

P: 312.496.0000

MEP-FP ENGINEER

20/10 ENGINEERING GROUP, LLC

1216 TOWER ROAD

SCHAUMBURG, IL 60173

P: 847.882.2010

Y COUNTY COLLEGE


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KEY PLAN:

SHEET STATUS: 04/25/2024

ISSUED FOR BID - NOT
FOR CONSTRUCTION

NO: DESCRIPTION: DATE:

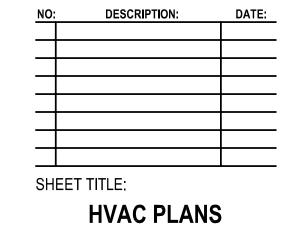


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HV1.00


EQUIPMENT		UNIT			APPROX.	APPROXIMATE OVERALL																				FANS		ELECTRICAL DATA			
TAG	LOCATION	SERVED	MANUFACTURER	MODEL	WEIGHT (LBS.)	DIME	ENSIONS W	(IN.) Гн	REJECTION (MBH)	REFRIGERANT TYPE	EAT (°F)	QUANTITY	MCA	MOCP	PHASE	VOLT	NOTES														
(ACC-1)	ROOF	(CRCU-1)	LIEBERT	MCM040EI	310	57	48	40	75	R-410A	100	1	1.4	15	3	480	1,2,														
(ACC-2)	R00F	CRCU-2	LIEBERT	MCM040EI	310	57	48	40	75	R-410A	100	1	1.4	15	3	480	1,2														

— EQUIPMENT INDICATED IN SCHEDULES HAVE BEEN PRE-PURCHASED BY OWNER AND SHALL BE INSTALLED BY CONTRACTOR. CONTRACTOR SHALL INSTALL ALL FIELD INSTALLED ACCESSORIES/OPTIONS.

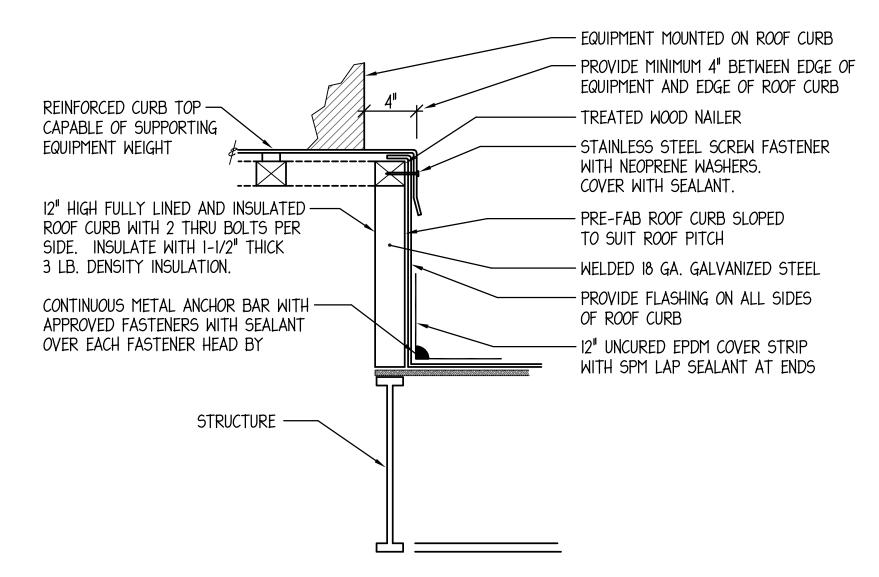

ROOF CURB DETAIL

NO SCALE

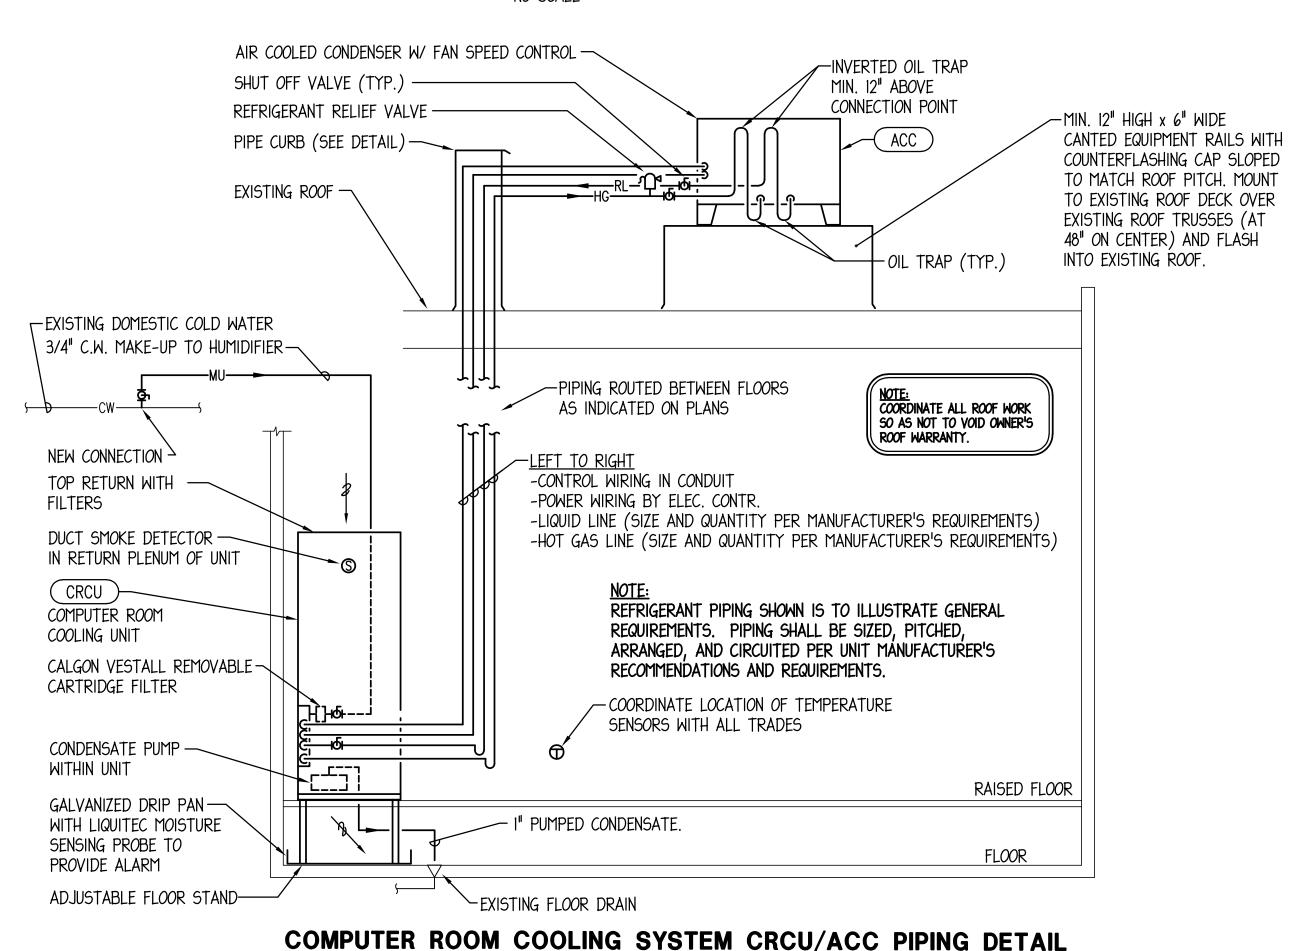

GENERAL NOTES - HVAC WORK:

1. ALL NEW WORK AND MATERIALS SHALL CONFORM TO CRYSTAL LAKE CODE AND MCC BUILDING STANDARDS

- 2. CONTRACTOR SHALL BE RESPONSIBLE FOR OBTAINING ALL REQUIRED PERMITS AND INSPECTIONS AND PAYING THEIR ASSOCIATED FEES.
- 3. NOISE AND VIBRATION WILL NOT BE TOLERATED. CONTRACTOR SHALL BID ON FURNISHING EVERY DETAIL TO ASSURE THIS END.
- 4. PATCH AND REFINISH ALL DAMAGED INSULATED SURFACES OF ALL EXISTING DUCTWORK, PIPING AND ASSOCIATED FITTINGS TO MATCH EXISTING WHERE NEW CONNECTIONS ARE BEING MADE.
- 5. CONTRACTORS SHALL PROVIDE A ONE YEAR WARRANTY ON ALL MATERIALS, EQUIPMENT AND LABOR FROM DATE OF SUBSTANTIAL COMPLETION.
- 6. CONTRACTORS SHALL PROVIDE IN WARRANTY LABOR AND MANUFACTURER WILL PROVIDE IN WARRANTY PARTS FOR EQUIPMENT WHICH HAS BEEN PRE-PURCHASED BY THE OWNER. CONTRACTOR SHALL RECEIVE THIS EQUIPMENT FROM THE OWNER AT THE PROJECT SITE OR OTHER COORDINATED LOCATION, AND THE CONTRACTOR SHALL COMPLETE REQUIRED ASSEMBLY WORK AND PROVIDE LABOR AND PROPER INSTALLATION.
- 7. THE LOCATIONS SHOWN FOR ALL DIFFUSERS, REGISTERS AND GRILLES, ETC. ARE DIAGRAMMATIC. EXACT LOCATION SHALL BE DETERMINED FROM THE REFLECTED CEILING PLANS AND/OR ON THE JOB SITE BY THE ARCHITECT/ENGINEER REPRESENTATIVES.
- 8. EXCEPT AS NOTED OTHERWISE, ALL SUPPLY, RETURN, AND EXHAUST DUCTWORK SHALL BE GALVANIZED SHEET METAL WITH SEALED JOINTS CONSTRUCTED AND INSTALLED IN ACCORDANCE WITH CURRENT SMACNA MANUAL. SIZES SHOWN ARE INSIDE FACE TO INSIDE FACE.
- 9. THE GAUGES OF IRON FOR DUCTS AND CASINGS AND SIZE OF STRUCTURAL REINFORCING ANGLES FOR DUCTS AND CASING SHALL BE SUCH AS TO PROVIDE ABSOLUTELY AIR TIGHT CONSTRUCTION FREE FROM PULSATION, DEFORMATION, OR VIBRATION AT NORMAL OPERATING PRESSURES.
- 10. ALL NEW RETURN DUCTWORK SHALL BE EXTERNALLY INSULATED MINIMUM I 1/2" THICK WITH FLEXIBLE FIBERGLASS INSULATION WITH VAPOR BARRIER JACKET.
- II. ALL ROUND CONCEALED FLEXIBLE DUCT SHALL BE WIREMOLD OR THERMOFLEX FACTORY INSULATED I" THICK MAXIMUM OF 5'-O" LONG TO DIFFUSERS/REGISTERS. FLEXIBLE DUCT MAY BE UTILIZED ONLY WHERE CONCEALED ABOVE ACCESSIBLE CEILINGS.
- 12. PROVIDE MANUAL VOLUME DAMPERS AT EACH BRANCH DUCT TAKEOFF IN RETURN DUCTWORK. PROVIDE TURNING VANES IN ALL SQUARE DUCT ELBOWS.
- 13. PAINT ALL INTERIOR DUCTWORK VISIBLE THROUGH AIR INLETS OR OUTLETS FLAT BLACK.
- 14. BALANCE DUCT SYSTEMS TO ACCOMPLISH AIR QUANTITIES SHOWN AT ALL INLETS/OUTLETS (NEW AND EXISTING) AS SHOWN ON DRAWING AND SUBMIT TEST REPORT FOR REVIEW BY OWNER AND ENGINEER.
- 15. ALL MAKE-UP WATER PIPING AND FITTINGS SHALL BE TYPE "L" COPPER, INSULATED WITH MINIMUM I" THICK FIBERGLASS PIPE INSULATION W/VAPOR BARRIER JACKET.

- 16. ALL REFRIGERANT PIPING SHALL BE TYPE "K" COPPER WITH WROUGHT COPPER SOLDER FITTINGS. PIPING SHALL BE CIRCUTED, SIZED, AND PITCHED PER EQUIPMENT MANUFACTURER'S RECOMMENDATIONS. INSULATE REFRIGERANT SUCTION AND HOT GAS LINES WITH 3/4" THICK AP/ARMAFLEX. PAINT EXTERIOR INSULATION WITH 2 COATS UV RESISTANT FINISH, COLOR AS SELECTED PER ARCHITECT.
- 17. DRIP PAN DRAIN PIPING SHALL BE SCHEDULE 40 PVC, OR TYPE "M" COPPER WITH 1/2" INSULATION.
- 18. ALL PIPING SHALL BE SUSPENDED WITH CLEVIS AND/OR TRAPEZE PIPE HANGERS. INSULATED PIPING SHALL REST ON SHEET METAL INSULATION SHIELDS. ANCHORS SHALL BE DRILLED INTO EXISTING FLOOR CONSTRUCTION.
- 19. FLUSH, CLEAN, PRESSURE TEST AND CHARGE ALL NEW PIPING SYSTEMS AND EXTENSION TO PIPING SYSTEMS. TESTING SHALL BE MINIMUM 50 PSI HIGHER THAN NORMAL OPERATING PRESSURE OF SYSTEM. CLEANING OF SYSTEM SHALL BE ACCOMPLISHED WITH H-O-H C-312 (OR EQUAL) CHEMICAL SOLUTION MULTIPURPOSE CLEANER UTILIZED IN STRICT ACCORDANCE WITH CHEMICAL TREATMENT SUPPLIER'S INSTRUCTION.
- 20. PROVIDE MIRO PIPE CURBS ON TOP OF 3/4" RUBBER ROOF GUARD PAD FOR NEW PIPE OR CONDUIT ON ROOF SUPPORT PIPING OR CONDUITS MAXIMUM 6' ON CENTER.
- 21. BALL VALVES SHALL BE STOCKHAM, MILWAUKEE, OR NIBCO MSS SP 110, 400 PSI WOG, ONE PIECE BRONZE BODY, CHROME PLATED BRASS BALL, FULL PORT, TEFLON SEATS, BLOW-OUT PROOF STEM, SOLDER ENDS, LEVER HANDLE.
- 22. ALL NEW PIPING SHALL BE IDENTIFIED WITH WRAP AROUND PIPE MARKERS. ALL NEW EQUIPMENT SHALL BE IDENTIFIED WITH PLASTIC ENGRAVED NAMEPLATES.
- 23. ALL TEMPERATURE CONTROL WORK SHALL MATCH EXISTING TRANE TRACER SYSTEM CURRENTLY INSTALLED IN BUILDING.
- 24. CONTRACTOR SHALL SETUP CRCU EQUIPMENT, INCLUDING INTERCONNECTING EQUIPMENT CONTROLLERS FOR EQUIPMENT COMMUNICATION PER EQUIPMENT MANUFACTURER'S RECOMMENDATIONS, INCLUDING NETWORK CONNECTIONS FOR CONNECTING VIA WEBSITE INTERFACE, AND SO THAT UNITS COMMUNICATE WITH EACH OTHER AND PROVIDE ALARMS TO OWNER. CONTRACTOR SHALL INSTALL ALL FIELD-INSTALLED ACCESSORIES AS RECOMMENDED BY EQUIPMENT MANUFACTURER.
- 25. ALL EQUIPMENT THERMOSTATS SHALL BE PROGRAMMABLE COMPATIBLE WITH ASSOCIATED EQUIPMENT. THERMOSTAT SELECTION SHALL BE MATCHED TO UNIT HEATING/COOLING STAGES.
- 26. LOW VOLTAGE WIRING SHALL BE U/L LISTED AND PLENUM RATED (LOW SMOKE PRODUCING). WIRING SHALL BE CONCEALED IN WALLS AND MAY BE INSTALLED WITHOUT CONDUIT ABOVE ACCESSIBLE LAY-IN CEILING SPACES ONLY.

ARCHITECT OF RECORD

DEMONICA KEMPER ARCHITECTS

125 N. HALSTED STREET, SUITE 301

CHICAGO, IL 60661

P: 312.496.0000

MEP-FP ENGINEER

20/10 ENGINEERING GROUP, LLC
1216 TOWER ROAD
SCHAUMBURG, IL 60173
P: 847.882.2010

HENRY COUNTY COLLE SERVER ROOM IMPROVEME

KEY PLAN:


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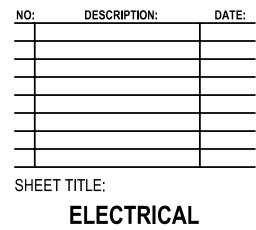
DETAILS, NOTES



MEP-FP ENGINEER 20/10 ENGINEERING GROUP, LLC **1216 TOWER ROAD** SCHAUMBURG, IL 60173

KEY PLAN:


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DEMOLITION PLANS
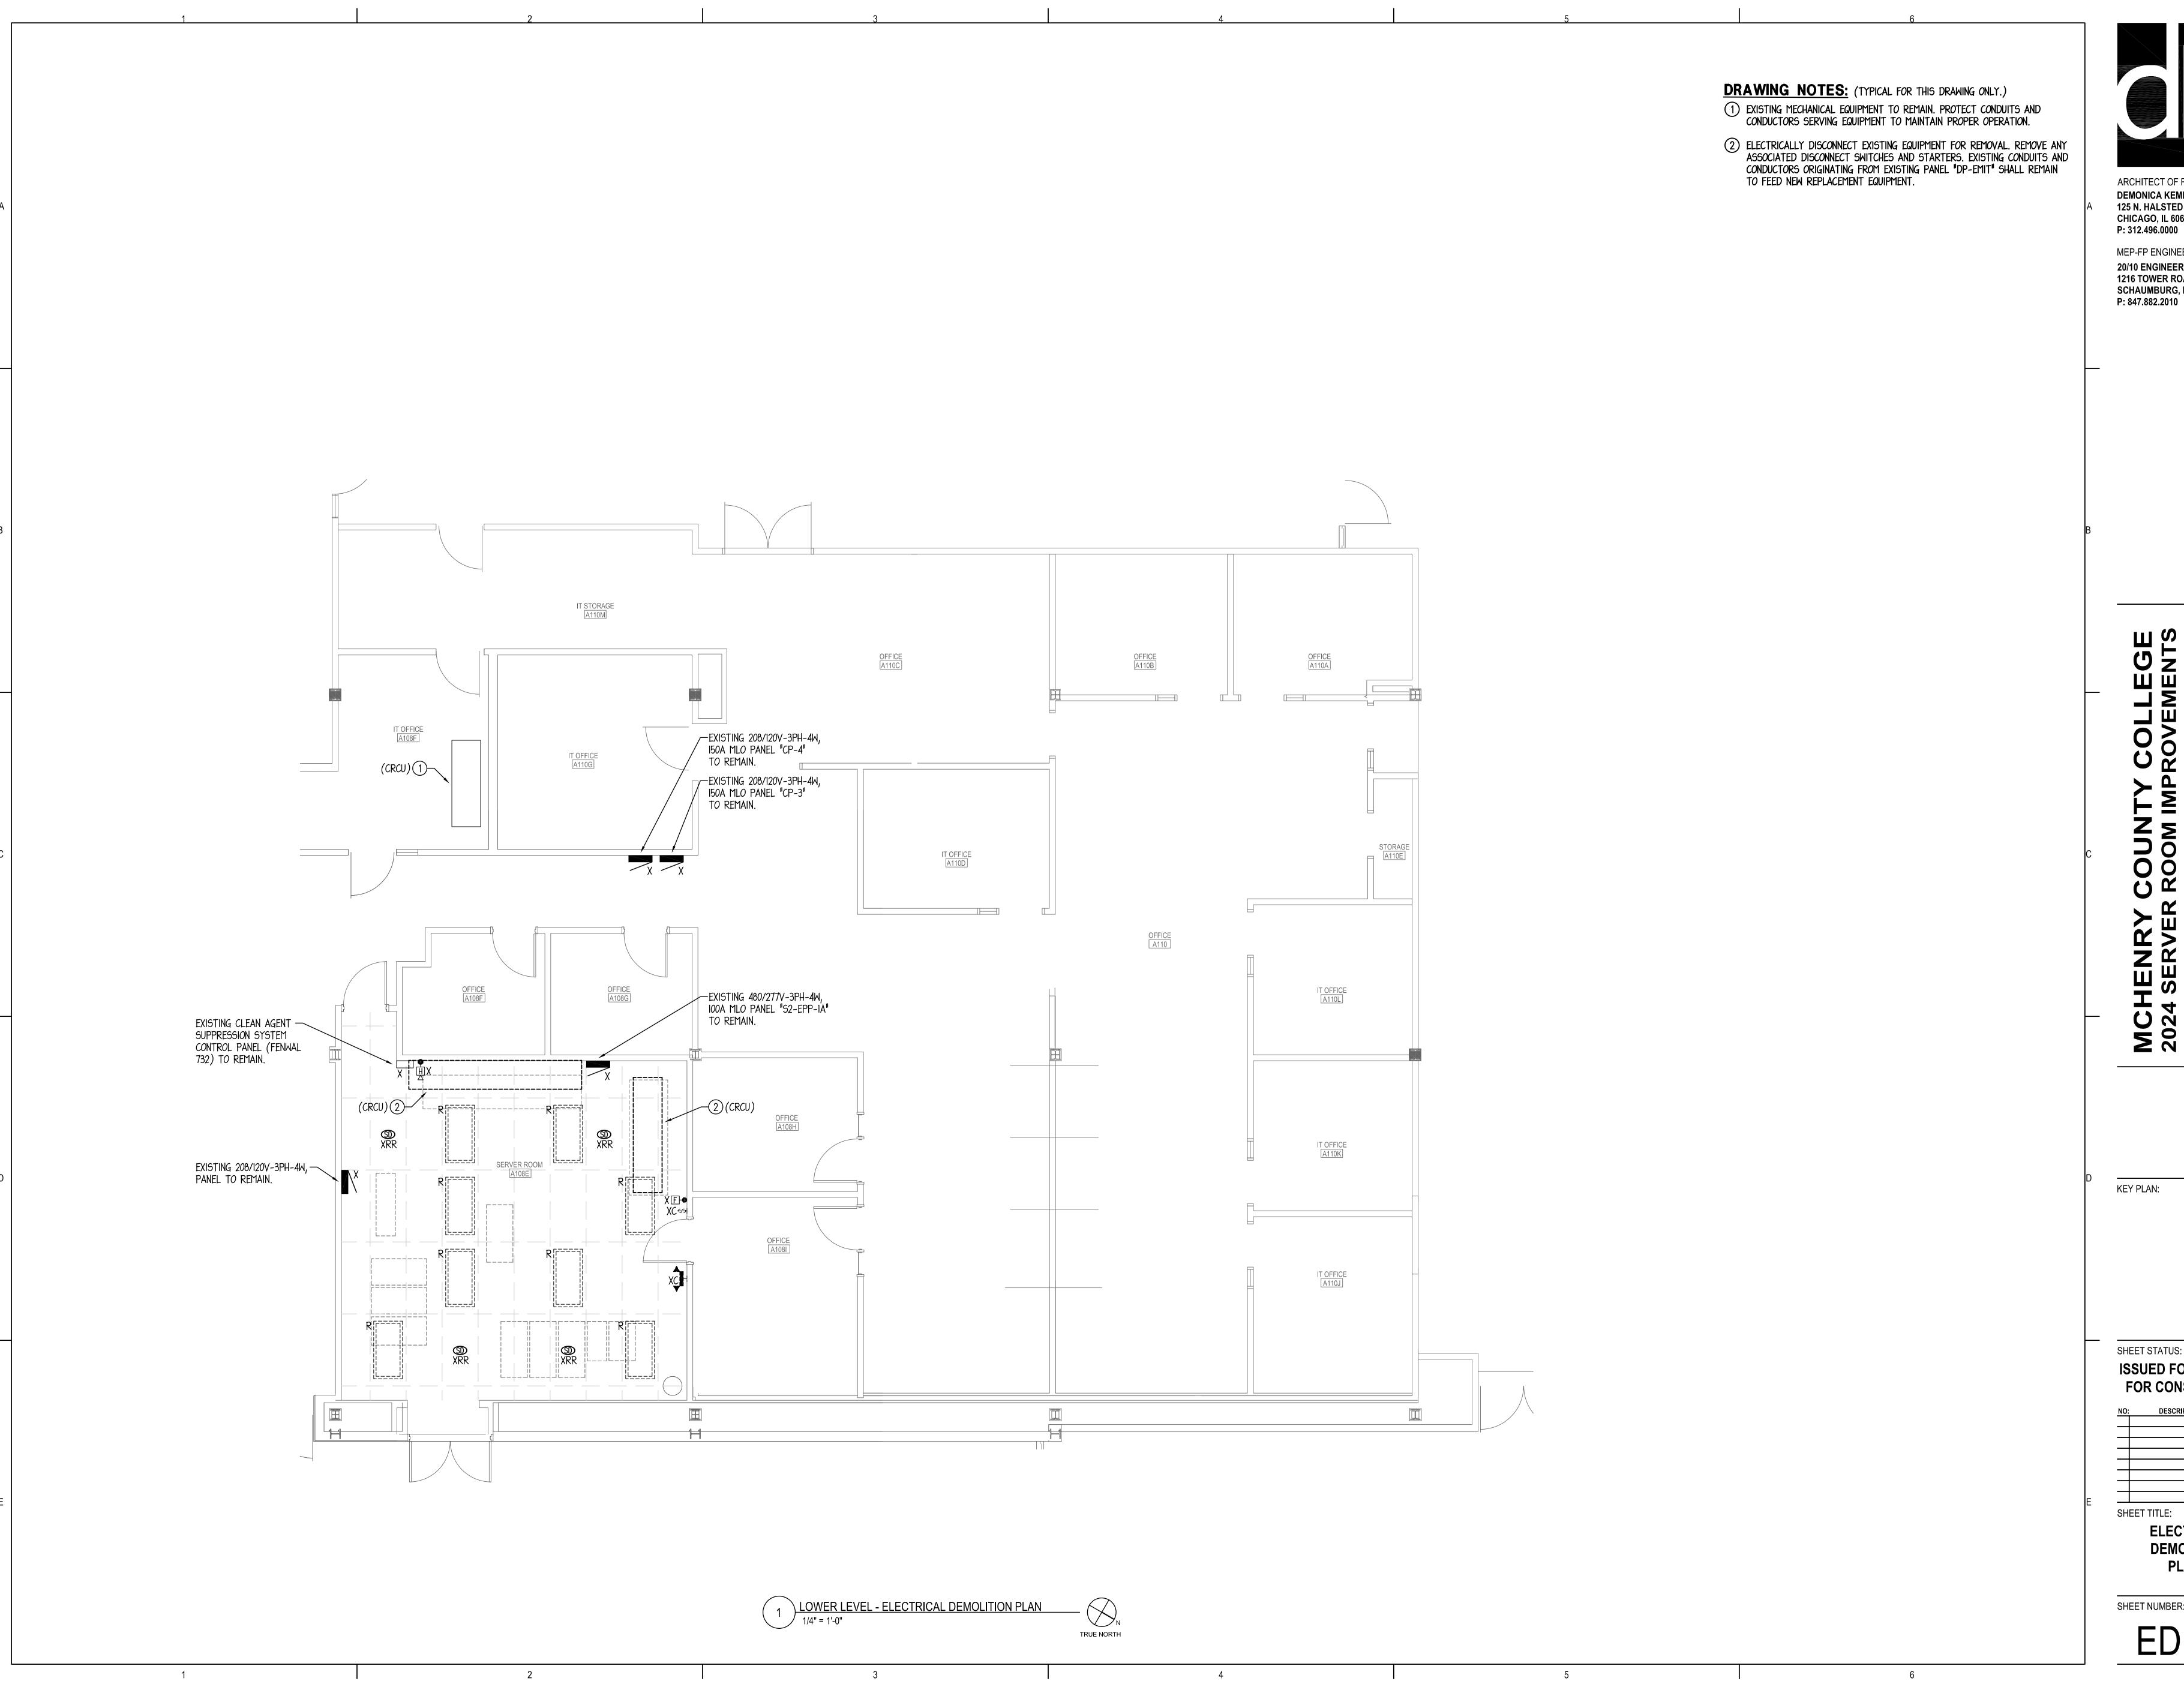
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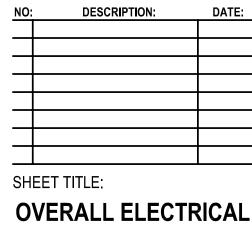





ARCHITECT OF RECORD DEMONICA KEMPER ARCHITECTS 125 N. HALSTED STREET, SUITE 301

20/10 ENGINEERING GROUP, LLC

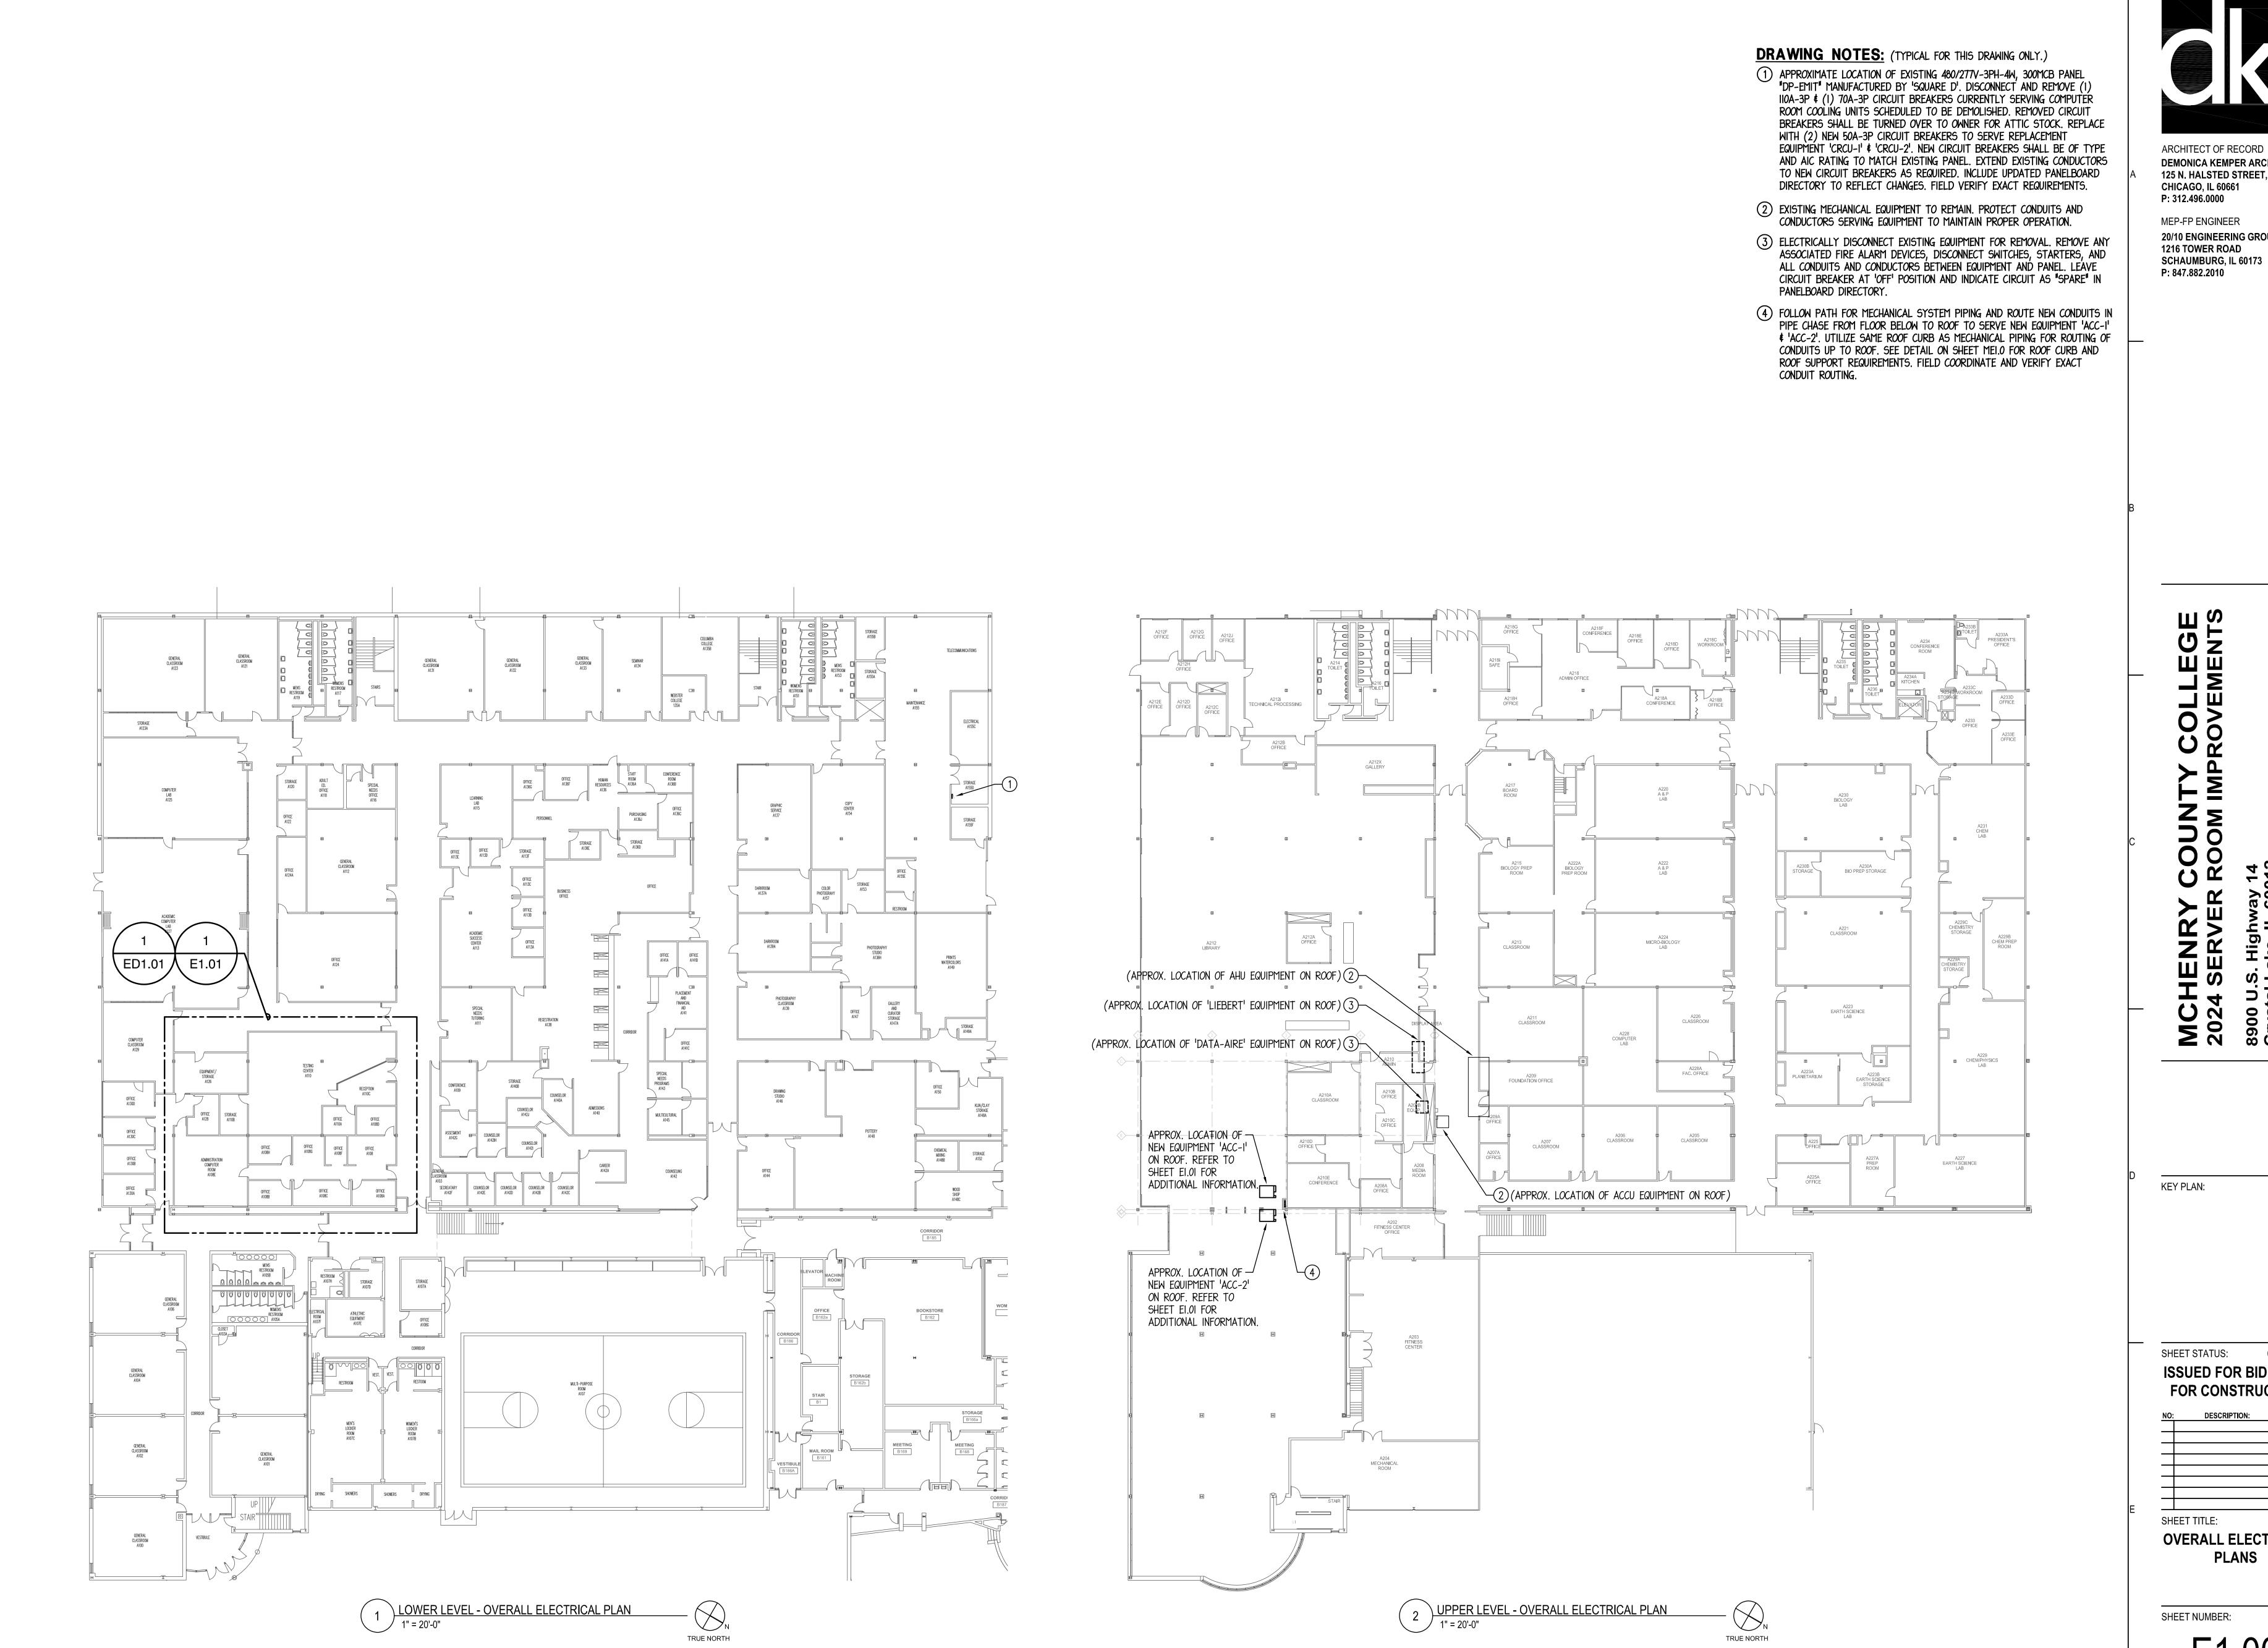ISSUED FOR BID - NOT FOR CONSTRUCTION NO: DESCRIPTION: DATE:




PLANS

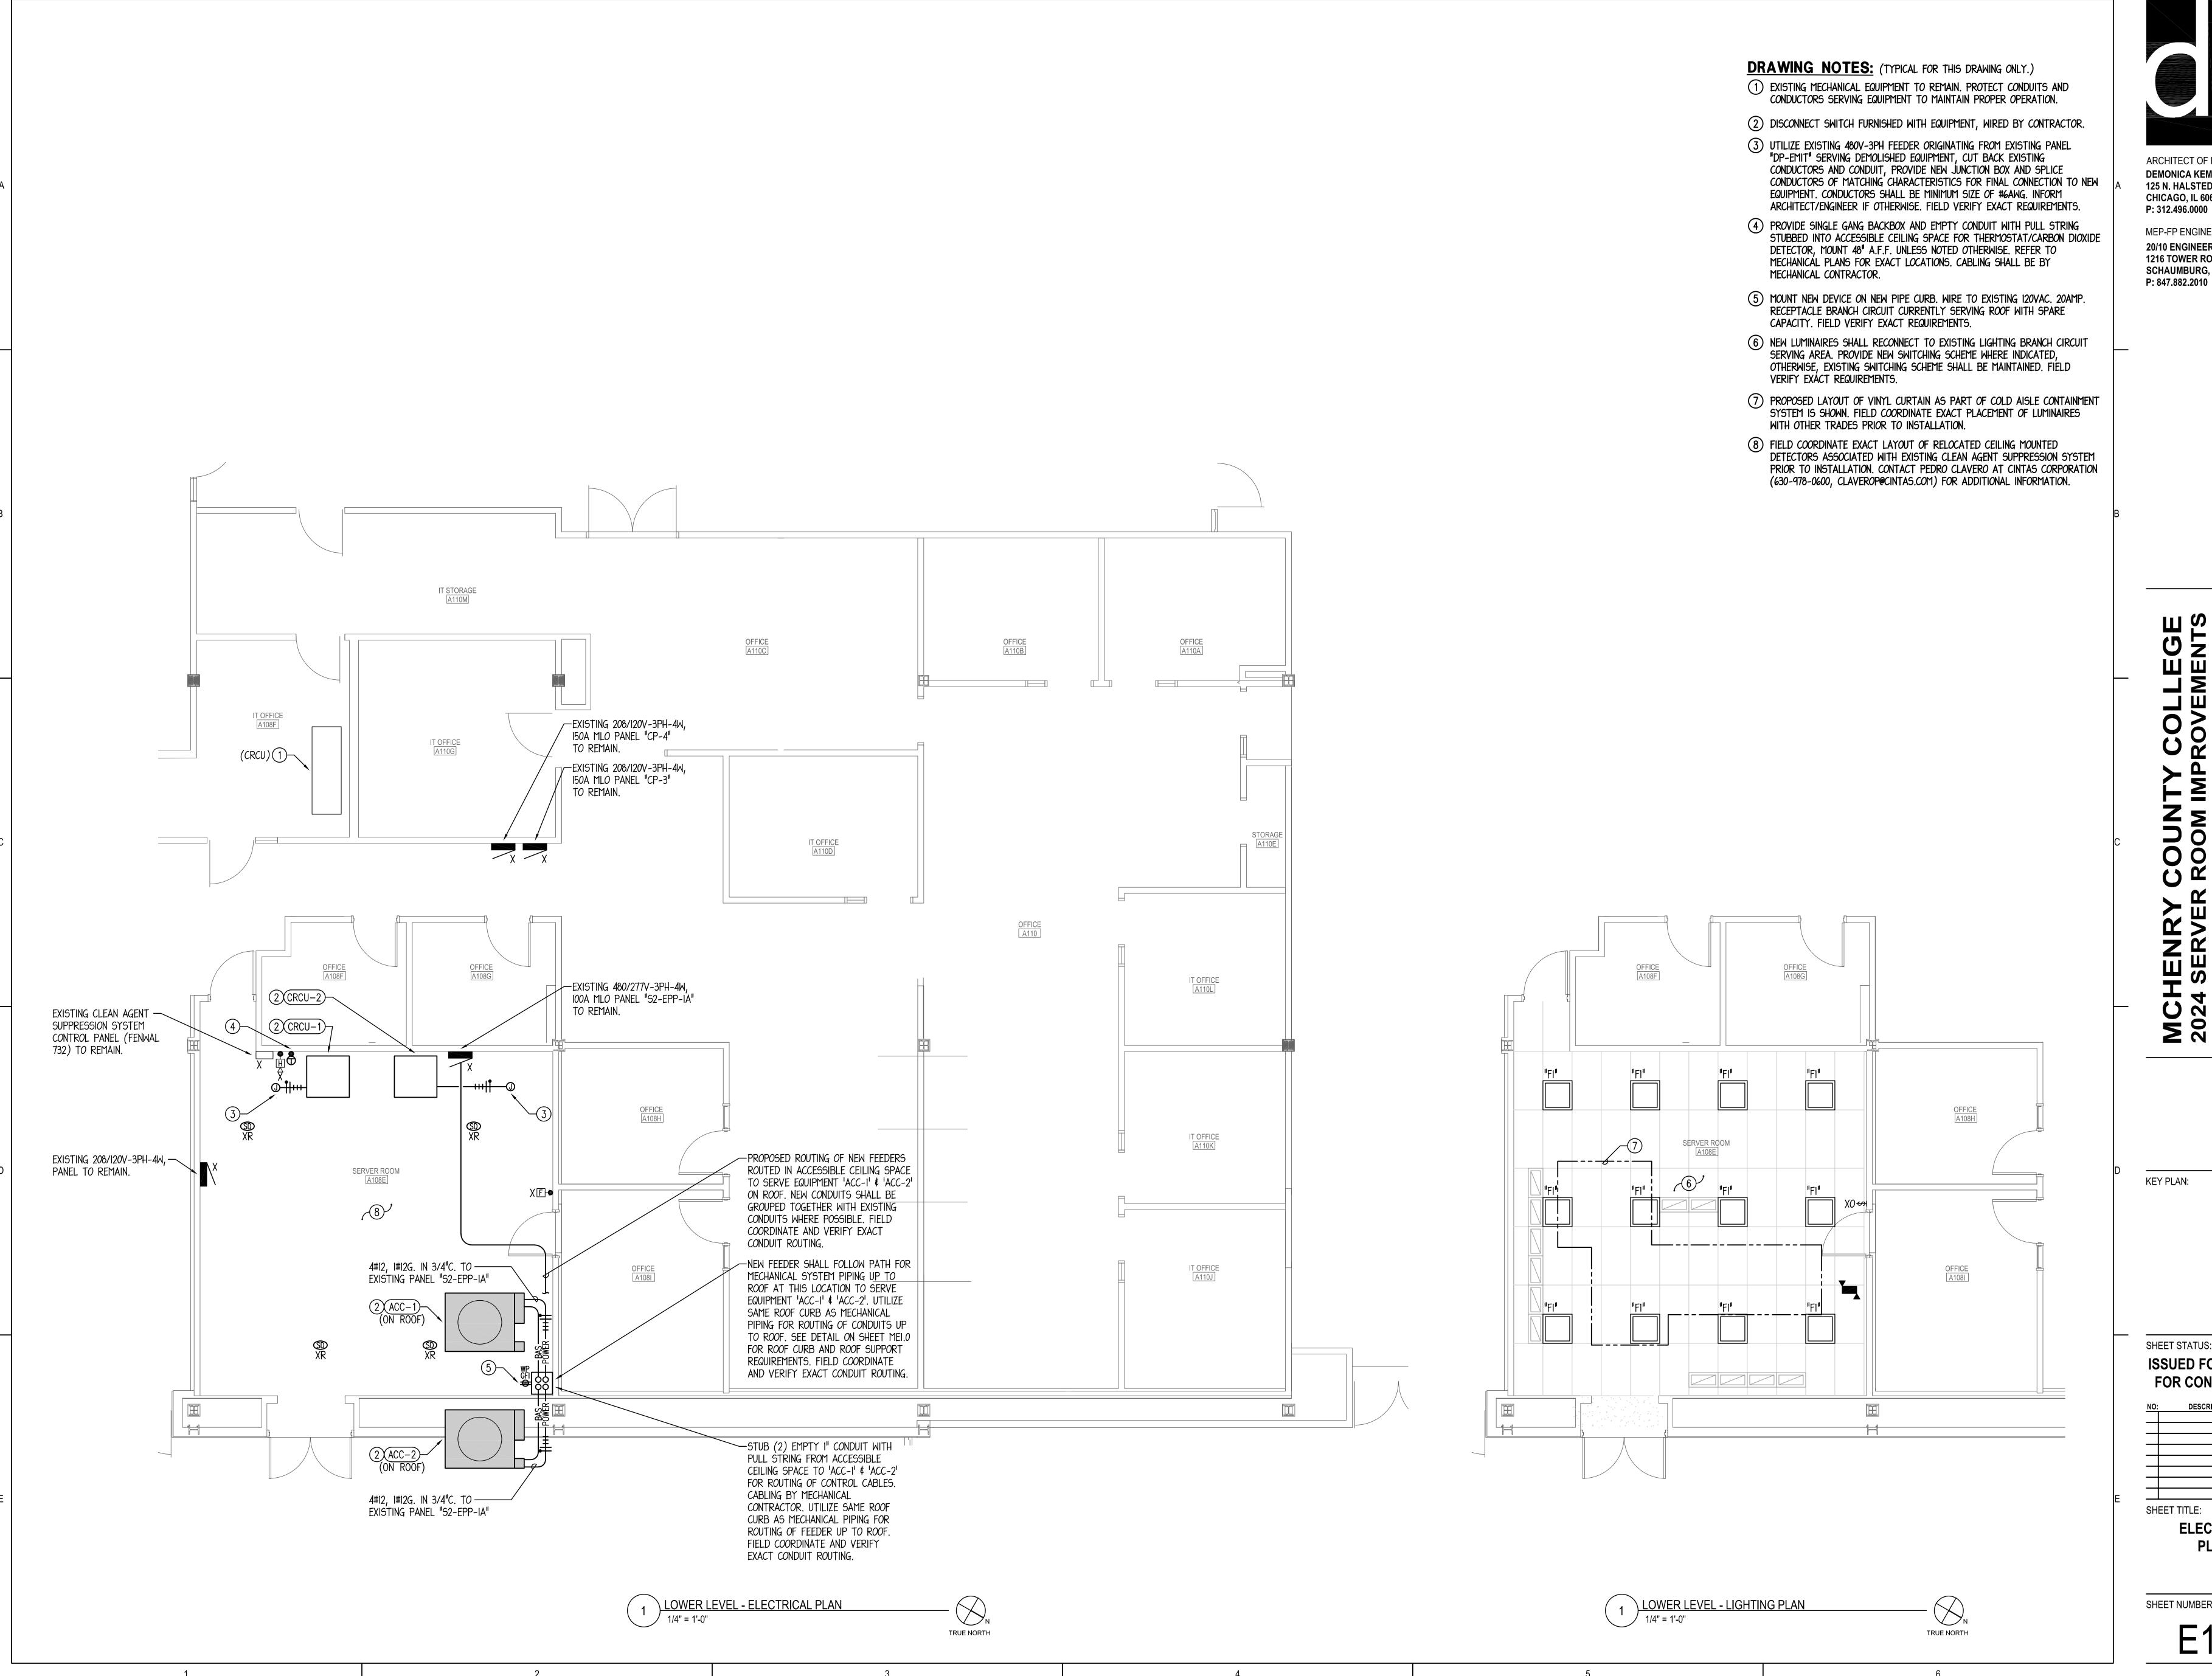

MEP-FP ENGINEER 20/10 ENGINEERING GROUP, LLC **1216 TOWER ROAD** SCHAUMBURG, IL 60173

KEY PLAN:

04/25/2024 SHEET STATUS: **ISSUED FOR BID - NOT** FOR CONSTRUCTION NO: DESCRIPTION: DATE:

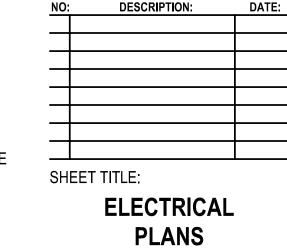

SHEET NUMBER:

	INTERIOR LUMINAIRE SCHEDULE								
TYPE	DESCRIPTION	MOUNTING	LAMPS	VOLTAGE	INPUT WATTAGE	MANUFACTURER & CATALOG NUMBER	ALTERNATE BID MANUFACTURER	NOTES	
"FI"	2'X2' LAY-IN LED PANEL	RECESSED	LED	UNV.	30.1	LITHONIA LIGHTING #CPX-2X2-3200LM-80CRI-40K-SWL-MINI0-ZT-MVOLT	HLI COLUMBIA LIGHTING, SIGNIFY DAY-BRITE	1	

CONTRACTOR TO PROVIDE ALL OPTIONS AND ACCESSORIES AS REQUIRED TO INSTALL LUMINAIRES IN VARYING CEILING TYPES AS SHOWN ON THE PLANS.

GENERAL NOTES:

- CONTRACTOR TO PROVIDE ALL NECESSARY MOUNTING HARDWARE AND LABOR FOR ALL LUMINAIRES.
- ALL LAY-IN CEILING GRID LUMINAIRES SHALL BE SUITABLE FOR USE WITH SPECIFIED CEILING GRID SYSTEM. ALL FINISH COLORS AND COLOR TEMPERATURES TO BE CONFIRMED BY THE ARCHITECT.

	EXIT SIGN & EMERGENCY LIGHTING SCHEDULE										
SYMB	OL TAG	DESCRIPTION	MOUNTING	LAMPS	VOLTAGE	MANUFACTURER & CATALOG NUMBER	ALTERNATE BID MANUFACTURER	NOTES			
	"EMI"	DUAL HEAD EMERGENCY LIGHTING UNIT WITH WHITE CONTEMPORARY THERMOPLASTIC ENCLOSURE	CEILING	LED	UNV.	LITHONIA LIGHTING #ELM6L-UVOLT-LTP-SDRT	HLI DUAL-LITE, SIGNIFY CHLORIDE	ı			

SCHEDULE NOTES:

CONNECT BATTERY UNIT TO LOCAL UNSWITCHED LIGHTING CIRCUIT.

GENERAL NOTES:

- CONTRACTOR TO PROVIDE ALL NECESSARY MOUNTING HARDWARE AND LABOR FOR ALL LUMINAIRES. BATTERIES SHALL BE CAPABLE OF PROVIDING ILLUMINATION FOR A MINIMUM OF 90 MINUTES.
- NOT ALL SYMBOLS WILL BE ACCOMPANIED BY TAGS ON THE PLANS FOR CLARITY PURPOSES.

PANEL SCHEDULE NOTE:

SCHEDULES FOR EXISTING PANELS ARE SHOWN FOR REFERENCE TO INDICATE SIZE AND QUANTITY OF NEW CIRCUIT BREAKERS REQUIRED. CONTRACTOR TO FIELD VERIFY EXISTING PANEL CHARACTERISTICS AND BRANCH CIRCUIT BREAKER LAYOUT.

PANEL SCHEDU	SCHEDULE: "6A"					SERV	ER RO	C.B. RATING: VIFk.A.I.C.		
VOLT: 480/277V-3PH-4W	MAINS: 100	DA ML	0	М	MOUNTING: SURFACE			TYPE: BOLT-ON		
REMARKS: EXISTING PANEL				ON'.						
USE AND/OR AREA SERVED	C/B	CIR.	ØΑ	V.A. ØB	ØC	CIR. NO.	C/B	USE AN	ID/OR AREA SERVED	
EXISTING LOAD	40 /		- 388	•		2	15 /	M: ACC	:-2	
		3	300	- 388		4				
	/ 3	5	,	300	- 388	6	3			
M: ACC-I	15 /	7	388		_ 300_	8	/	BUSSEI	O SPACE	
		9		388		10		BUSSEI	O SPACE	
	3	11	1		388	12		BUSSEI	O SPACE	
BUSSED SPACE	/	13	-			14		BUSSEI	O SPACE	
BUSSED SPACE		15		-	7	16		BUSSEI	O SPACE	
BUSSED SPACE		17			-	18		BUSSEI	O SPACE	
BUSSED SPACE		19	-			20		BUSSEI	O SPACE	
BUSSED SPACE		21		-	7	22		BUSSEI	O SPACE	
BUSSED SPACE		23			-	24		BUSSEI	O SPACE	
BUSSED SPACE		25	-			26			O SPACE	
BUSSED SPACE		27	-	1	7				O SPACE	
BUSSED SPACE		29		1	-	28			O SPACE	
TOTAL CONNECTED LOAI	D PER PHA	SE:	776	776	776	30 TOTA	AL V.A	. = 2,3		

- □ PROVIDE NEW CIRCUIT BREAKER OF TYPE AND AIC RATING TO MATCH EXISTING PANEL TO SERVE NEW LOAD AS INDICATED. UTILIZE EXISTING BUSSED SPACE FOR INSTALLATION OF NEW CIRCUIT BREAKER.
- Δ UTILIZE EXISTING SPARE CIRCUIT BREAKER OR CIRCUIT BREAKER MADE AVAILABLE FROM DEMOLITION WORK TO SERVE NEW LOAD AS INDICATED.

- **ELECTRICAL SYMBOL LIST** (NOTE: NOT ALL SYMBOLS ARE USED IN THE PROJECT.) 2' X 4' LUMINAIRE, RECESSED OR SURFACE MOUNTED PER LUMINAIRE SCHEDULE. 2' X 2' LUMINAIRE, RECESSED OR SURFACE MOUNTED PER LUMINAIRE SCHEDULE. I' X 4' LUMINAIRE, RECESSED OR SURFACE MOUNTED PER LUMINAIRE SCHEDULE. ROUND LUMINAIRE. RECESSED OR SURFACE MOUNTED PER LUMINAIRE SCHEDULE. HALF SHADING DENOTES UNSWITCHED LUMINAIRE (NIGHTLIGHT). EMERGENCY EXIT FIXTURE, SURFACE CEILING MOUNTED, SINGLE OR DOUBLE FACE, WITH OR WITHOUT DIRECTIONAL ARROWS. EMERGENCY EXIT FIXTURE, SURFACE WALL MOUNTED, SINGLE OR DOUBLE FACE, WITH OR WITHOUT DIRECTIONAL ARROWS. EMERGENCY BATTERY LIGHT FIXTURE. SELF-CONTAINED EMERGENCY LUMINAIRE WITH DUAL WEATHERPROOF REMOTE HEADS, BATTERY BACK-UP AND SOLID STATE CHARGER PER SCHEDULE. SINGLE POLE 20 AMP 120-277V VOLT TOGGLE SWITCH INSTALLED 48" A.F.F. SINGLE POLE 20 AMP 120-277V TOGGLE SWITCH WITH PILOT LIGHT INSTALLED 48 A.F.F. WALL SWITCH/OCCUPANCY SENSOR PER LIGHTING CONTROL SCHEDULE. OCCUPANCY SENSOR, LETTER INDICATES TYPE PER LIGHTING CONTROL SCHEDULE. DENOTES ELECTRICAL DEVICE MOUNTED ON SURFACE RACEWAY, WIREMOLD V700 OR SURFACE MOUNTED (EXPOSED) CONDUIT, BACKBOX FOR DEVICE AS SHOWN SURFACE MOUNTED (EXPOSED) RECEPTACLE OUTLET(S) AND CONDUIT, INSTALLATION IN NON-PUBLIC AREAS ONLY (JANITOR CLOSET, ELECTRIC, BOILER ROOMS) FAAP 20A. 2P, 3 WIRE, GROUNDING TYPE, 125V. SPECIFICATION-GRADE, TAMPER-RESISTANT TYPE DUPLEX RECEPTACLE NEMA 5-20R INSTALLED +16" A.F.F. UNLESS NOTED OTHERWISE. - "GFI" DENOTES RECEPTACLE EQUIPPED WITH INTEGRAL GROUND FAULT CIRCUIT INTERRUPTER. - "WP" DENOTES RECEPTACLE WITH WHILE-IN-USE WEATHERPROOF COVER.
 - 20A. 2P, 3 WIRE, GROUNDING TYPE, 125V. SPECIFICATION-GRADE, TAMPER-RESISTANT TYPE DUPLEX RECEPTÀCLE NEMA 5-20R INSTALLED 6" ABOVE COUNTER TOP OR +42" A.F.F. UNLESS NOTED OTHERWISE. - "GFI" DENOTES RECEPTACLE EQUIPPED WITH INTEGRAL GROUND FAULT CIRCUIT
- INTERRUPTER. TWO 20A. 2P, 3 WIRE, GROUNDING TYPE, SPECIFICATION-GRADE, TAMPER-RESISTANT TYPE DUPLEX RECEPTACLES NEMA 5-20R INSTALLED +16" A.F.F. UNLESS NOTED OTHERWISE. - "GFI" DENOTES RECEPTACLE EQUIPPED WITH INTEGRAL GROUND FAULT CIRCUIT
- POWER OUTLET, CEILING MOUNTED THERMOSTAT/CO2 SENSOR.

ELECTRICAL ABBREVIATIONS

FULL LOAD AMPS

		_					
Α	AMPERES	G, GRD.	GROUND	MIN	MINIMUM	VA	VOLT - AMPERES
AFCI	ARC FAULT CIRCUIT INTERRUPTER	GFI	GROUND FAULT CIRCUIT INTERRUPTER	MLO	MAIN LUGS ONLY	W	WATTS
AEE		CEDI		MOCP	MAXIMUM OVERCURRENT	WG	WIRE GUARD
A.F.F.	ABOVE FINISHED FLOOR	GFPI	GROUND FAULT PROTECTIVE EQUIPMENT		PROTECTION	WP	WEATHER PROOF
C	CONDUIT	UD	HADCEDALIED	PT	POTENTIAL TRANSFORMER	VEMD	TRANCFORMER
C/B	CIRCUIT BREAKER	HP	HORSEPOWER	SPD	SURGE PROTECTIVE DEVICE	XFMR	TRANSFORMER
CT.	CURRENT TRANSFORMER	I.T.	INFORMATION TECHNOLOGY	T D	TIMPED DECICTIVIT	IP	SINGLE POLE
CT	CURRENT TRANSFORMER	KCM	THOUSAND CIRCULAR MILS	TR	TAMPER-RESISTANT	2P	TWO POLE
CU	COPPER	MIV	MANIMINA	TYP.	TYPICAL	20	TIPE DOLE
EC	ELECTRICAL CONTRACTOR	MAX	MAXIMUM	U.N.O.	UNLESS NOTED OTHERWISE	3P	THREE POLE
		MCA	MINIMUM CIRCUIT AMPS			φ	PHASE
EM	EMERGENCY			V	VOLTS		

MCB MAIN CIRCUIT BREAKER

CEILING JUNCTION BOX. WALL MOUNTED JUNCTION BOX.

JUNCTION BOX WITH FLEXIBLE CONDUIT AND FINAL CONNECTION TO EQUIPMENT.

FIRE ALARM DUCT SMOKE DETECTOR REMOTE KEYED TEST STATION.

FIRE ALARM SYSTEM STROBE NOTIFICATION DEVICE INSTALLED +80" A.F.F.

FIRE ALARM SYSTEM STROBE NOTIFICATION DEVICE, CEILING MOUNTED.

FIRE ALARM SYSTEM HORN NOTIFICATION DEVICE, CEILING MOUNTED.

FIRE ALARM SYSTEM HORN/STROBE NOTIFICATION DEVICE, CEILING MOUNTED.

CONDUIT ROUTED CONCEALED IN WALLS AND CEILING. HASH MARKS DENOTE QUANTITY OF

CONDUIT ROUTED EXPOSED. INSTALL PARALLEL TO WALLS AND CEILINGS. HASH MARKS

CONDUIT ROUTED BELOW GRADE. HASH MARK DENOTES QUANTITY OF #12

─LONG TICK MARK DENOTES NEUTRAL CONDUCTOR, #10 AWG MINIMUM

SHORT TICK MARK DENOTES LINE (HOT) OR SWITCH LEG CONDUCTOR, #12 AWG MINIMUM.

FIRE ALARM SYSTEM HORN/STROBE NOTIFICATION DEVICE INSTALLED +80" A.F.F.

FIRE ALARM DUCT SMOKE DETECTOR.

FIRE ALARM MAGNETIC DOOR HOLDER DEVICE.

FIRE ALARM SYSTEM CEILING SMOKE DETECTOR.

FIRE ALARM SYSTEM CEILING HEAT DETECTOR.

"FT" DENOTES FIXED TEMPERATURE.

WATER FLOW SWITCH.

TAMPER SWITCH.

FIRE ALARM BELL.

FIRE ALARM CONTROL PANEL.

FIRE ALARM ANNUNCIATOR PANEL.

#12 CONDUCTORS OR AS NOTED.

CONDUCTORS OR AS NOTED.

—— DENOTES CONDUIT, 3/4" MINIMUM

CIRCUIT BREAKER PANELBOARD.

DENOTE QUANTITY OF #12 CONDUCTORS OR AS NOTED.

— DENOTES INSULATED GROUND WIRE, #12 AWG MINIMUM

FIRE ALARM SYSTEM PULL STATION INSTALLED +48" A.F.F.

ARCHITECT OF RECORD DEMONICA KEMPER ARCHITECTS 125 N. HALSTED STREET, SUITE 301 **CHICAGO, IL 60661**

MEP-FP ENGINEER 20/10 ENGINEERING GROUP, LLC 1216 TOWER ROAD SCHAUMBURG, IL 60173 P: 847.882.2010

P: 312.496.0000

KEY PLAN:

ISSU	STATUS: JED FOR I R CONSTI	
NO:	DESCRIPTION	: DATE:
#		

SHEET TITLE:

ELECTRICAL SYMBOL LIST AND SCHEDULES

SHEET NUMBER:

DEMOLITION SYMBOLS DESCRIPTION EXISTING ELECTRICAL EQUIPMENT OR OUTLET TO BE REMOVED. EXISTING ELECTRICAL EQUIPMENT OR OUTLET TO REMAIN. EXISTING ELECTRICAL EQUIPMENT OR OUTLET TO BE REMOVED AND JUNCTION BOX CAPPED OR REUSED AS REQUIRED. XO NEW ELECTRICAL EQUIPMENT INSTALLED OVER EXISTING OUTLET. EXISTING ELECTRICAL EQUIPMENT OR OUTLET TO BE REMOVED, RELOCATED AND JUNCTION BOX REMOVED OR CAPPED AS REQUIRED. STORE AND PROTECT EXISTING DEVICE FOR RE-USE AND RE-INSTALLATION. EXISTING ELECTRICAL EQUIPMENT OR OUTLET RELOCATED (NEW LOCATION). EXTEND EXISTING FEED AS REQUIRED TO MAINTAIN DEVICE/EQUIPMENT OPERATION. PROVIDE NEW FEED OF MATCHING SPECIFICATIONS IN SITUATIONS WHERE THEY CANNOT BE SPLICED OR ARE NOT OF SUFFICIENT LENGTH TO REACH NEW LOCATION. EXISTING ELECTRICAL EQUIPMENT OR OUTLET TO BE TEMPORARILY REMOVED AND REINSTALLED IN SAME LOCATION. XA EXISTING ELECTRICAL EQUIPMENT OR OUTLET TO BE ABANDONED. XM | EXISTING ELECTRICAL EQUIPMENT OR OUTLET TO BE MODIFIED. XW EXISTING ELECTRICAL EQUIPMENT TO BE REWIRED.

NOTE: NOT ALL SYMBOLS MAY BE USED.

ELECTRICAL SPECIFICATIONS

- I. ALL WORK SHALL BE DONE IN ACCORDANCE WITH THE 2017 NATIONAL ELECTRICAL CODE WITH CITY OF CRYSTAL LAKE AMENDMENTS AND SHALL CONFORM TO MCHENRY COUNTY COLLEGE STANDARDS.
- 2. PROVIDE ALL PERMITS AND INSPECTION FEES.
- 3. ALL MATERIAL AND LABOR SHALL BE GUARANTEED FOR ONE YEAR AFTER FINAL ACCEPTANCE BY THE OWNER.
- 4. CONTRACTOR SHALL PROVIDE THEIR OWN RIGGING, SCAFFOLDING, RUBBISH REMOVAL, AND LEAVE SPACE BROOM
- 5. MINIMUM SIZE CONDUIT SHALL BE 3/4" EMT, PROVIDE IMC WHERE EXPOSED TO WET OR DAMP LOCATIONS. IMC SHALL HAVE THREADED CONNECTIONS. TRANSITION TO LIQUID-TIGHT FLEXIBLE METAL CONDUIT FOR FINAL CONNECTION (MAXIMUM LAST 6 FEET) OF CONDUCTORS SERVING EQUIPMENT SUBJECT TO VIBRATION.
- 6. MINIMUM SIZE CONDUCTOR SHALL BE #12 THHN, OR THWN WHERE REQUIRED. CONDUCTOR MATERIAL SHALL BE COPPER ONLY.
- 7. PROVIDE SEPARATE, INSULATED EQUIPMENT GROUNDING CONDUCTOR WITHIN EACH FEEDER AND BRANCH CIRCUIT RACEWAY. TERMINATE EACH END ON SUITABLE LUG, BUS, OR BUSHING.
- 8. BRANCH CIRCUIT CONDUCTORS FOR 20 AMP RECEPTACLES AND LIGHTING CIRCUITS SHALL BE ADJUSTED FOR **VOLTAGE DROP:**
- A. 120/208V: 0-75' #12AWG MINIMUM 75'-150' #10AWG MINIMUM 150'-225' #8AWG MINIMUM #12AWG MINIMUM B. 277/480V: 0-1001 100'-200' #10AWG MINIMUM

200'-300'

9. CONDUCTOR SIZES #14 AWG, #12 AWG, AND #10 AWG SHALL BE SOLID. CONDUCTOR SIZES #8 AWG AND LARGER SHALL BE STRANDED. ALL CONDUCTORS SHALL BE COLOR CODED.

#8AWG MINIMUM

- 10. CONTRACTOR SHALL PROVIDE ALL NECESSARY CUTTING AND PATCHING INCLUDING SLEEVES AND INSERTS.
- II. COLOR AND FINISH OF ALL MATERIALS SHALL BE SUBJECT TO REVIEW AND APPROVAL BY OWNER. PROVIDE SHOP DRAWINGS REQUIRED FOR FINISH AND COLOR SELECTION.
- 12. ALL NEW CIRCUIT BREAKERS SHALL BE BOLT-ON BREAKERS (10,000 A.I.C. MINIMUM), COMPATIBLE WITH EXISTING PANELBOARD, PROVIDE TYPEWRITTEN DIRECTORIES IN ALL PANELS.
- 13. CONTRACTOR SHALL VISIT THE SITE TO ASCERTAIN ALL WORK INVOLVED IN THE PROJECT.
- 14. CONTRACTOR SHALL COORDINATE THEIR WORK WITH OTHER CONTRACTORS ON THE PROJECT.
- 15. CONTRACTOR SHALL MAKE NECESSARY MODIFICATIONS AND ADJUSTMENTS TO ALL ELECTRICAL ITEMS AND EQUIPMENT AS MAY BE REQUIRED BY THIS WORK.
- 16. LAY-IN LUMINAIRES SHALL BE SUPPORTED INDEPENDENTLY FROM CEILING FRAMES BY TYING TWO HANGER WIRES ON OPPOSITE CORNERS OF THE LUMINAIRE UP TO A STRUCTURAL MEMBER.
- 17. ALL ELECTRICAL EQUIPMENT MUST MAINTAIN WORKING CLEARANCES AS REQUIRED BY NEC.
- 18. CONTRACTOR SHALL BE RESPONSIBLE AND PAY FOR ALL CORING, CUTTING, PATCHING, REPAIRING, REFINISHING AND REMOVAL/REPLACEMENT OF NEW OR EXISTING BUILDING CONSTRUCTION REQUIRED TO ACCOMMODATE THE INSTALLATION OR REMOVAL OF THEIR WORK. REMOVE, STORE, AND REINSTALL CEILING TILES AS REQUIRED TO INSTALL WORK ABOVE EXISTING REMOVABLE CEILINGS WHICH REMAIN; REPLACE TILES BROKEN OR DAMAGED DURING CONSTRUCTION. ALL PATCHING, REPAIRING, AND REFINISHING WORK TO OTHER FINISHES AND STRUCTURAL ELEMENTS SHALL BE PERFORMED BY THOSE REGULARLY INVOLVED IN THAT TRADE AND SHALL MATCH THE ADJACENT CONSTRUCTION AS CLOSELY AS POSSIBLE WHILE MAINTAINING EXISTING FIRE RATINGS. CONTRACTOR SHALL BE RESPONSIBLE FOR DETERMINING EXISTING FIRE RATINGS OF CEILINGS AND PARTITIONS SYSTEMS. CARE SHALL BE TAKEN SO AS NOT TO DAMAGE ANY EXISTING BUILDING CONSTRUCTION OR ITEMS THAT ARE TO REMAIN, ANY EXISTING FINISHES THAT ARE DAMAGED DURING THE INSTALLATION OF NEW WORK OR REMOVAL OF EXISTING WORK SHALL BE REPAIRED, REPLACED, AND PAID FOR BY THE INSTALLING CONTRACTOR TO THE SATISFACTION OF THE ARCHITECT AND OWNER. REFER TO ARCHITECTURAL DRAWINGS FOR EXISTING BUILDING CONSTRUCTION THAT IS TO REMAIN AND, THEREFORE, SUBJECT TO PATCHING, REPAIRING, REFINISHING, AND REMOVAL/REPLACEMENT.
- 19. NEW LIGHTING CONTROL CABLES ROUTED ABOVE ACCESSIBLE CEILINGS SHALL BE PLENUM RATED. CABLING SHALL BE SUPPORTED AT INTERVALS NOT EXCEEDING 5 FEET UTILIZING J-HOOKS SUPPORTED BY STRUCTURAL MEMBERS ABOVE ACCESSIBLE CEILINGS. LIGHTING CONTROL CABLES SHALL BE CONTAINED IN A COMPLETE RACEWAY SYSTEM WITH JUNCTION BOXES WHERE ROUTED THROUGH INACCESSIBLE CEILINGS OR UNFINISHED AREAS WITH EXPOSED STRUCTURE. CABLING AND RACEWAY SHALL BE ROUTED PARALLEL OR PERPENDICULAR TO STRUCTURAL MEMBERS.
- 20. FLEXIBLE RACEWAY SYSTEMS SHALL NOT BE USED TO PENETRATE ROOFS, FLOORS, OR AIR/MOISTURE BARRIERS.
- 21. RACEWAY SYSTEMS SHALL NOT BE ROUTED THROUGH OR IN HVAC DUCTS.
- 22. WIRING DEVICES:
- ACCEPTABLE MANUFACTURERS: HUBBELL, LEVITON, PASS & SEYMOUR OR COOPER.

SWITCHES SHALL BE COMMERCIAL GRADE, 120/277 VOLT, BACK AND SIDE WIRED, TOGGLE TYPE RATED AT 20 AMPERES AND UL LISTED.

RECEPTACLES SHALL BE SPECIFICATION GRADE, POLARIZED, GROUNDED, DUPLEX, BACK AND SIDE WIRED, RATED 20 AMPERES AND UL LISTED.

23. DEVICE PLATES:

- SWITCH AND RECEPTACLE PLATES IN FINISHED AREAS SHALL BE THERMOPLASTIC NYLON FROM SAME MANUFACTURER AS WIRING DEVICES.
- 24. ALL NEW FIRE ALARM CABLING ABOVE ACCESSIBLE CEILINGS SHALL BE PLENUM RATED CABLE OF TYPE COMPATIBLE WITH EXISTING BUILDING FIRE ALARM SYSTEM.
- 25. ALL NEW FIRE ALARM DEVICE(S) SHALL BE UL LISTED AND OF TYPE AND MANUFACTURER TO MATCH EXISTING. NEW FIRE ALARM DEVICE(S) SHALL BE INTEGRATED INTO EXISTING FIRE ALARM SYSTEM.
- 26. ALL NEW FIRE ALARM CABLES SHALL BE IN CONDUIT EXCEPT WHERE LOCATED ABOVE ACCESSIBLE CEILINGS. FIRE ALARM CONDUITS SHALL BE 1/2" MINIMUM. JUNCTION BOXES SERVING FIRE ALARM DEVICES SHALL BE RED. PROVIDE #18 AWG MINIMUM SIZE CONDUCTOR FOR INITIATING CIRCUITS AND #12 AWG MINIMUM SIZE CONDUCTOR FOR NOTIFICATION CIRCUITS. ALL CONDUIT/BOXES SHALL BE CONCEALED IN WALLS UNLESS WALL IS OF EXISTING MASONRY CONSTRUCTION WHERE ARCHITECT APPROVED SURFACE MOUNTED RACEWAY/BOXES MAY BE UTILIZED (WIREMOLD OR EQUAL).

27. LUMINAIRES:

LUMINAIRES SHALL BE PROVIDED AS SPECIFIED ON DRAWINGS. LUMINAIRES SHALL BE HUNG AND MOUNTED IN PLACE, PROPERLY WIRED, TESTED, AND LEFT READY FOR OPERATION BY THE CONTRACTOR.

WHERE LOCATED BENEATH DUCTWORK, THE CONTRACTOR IS PROHIBITED FROM PUNCTURING THE DUCTWORK OR MOUNTING LUMINAIRES DIRECTLY TO THE DUCTWORK. THE CONTRACTOR MAY MOUNT THE LUMINAIRES TO THE DUCTWORK SUPPORT MEMBERS.

HANGING DEVICES, BRACKETS, ENCLOSURES, AND OTHER ACCESSORIES SHALL BE PROVIDED FOR A COMPLETE INSTALLATION AND SHALL BE INSTALLED BY THE CONTRACTOR.

LUMINAIRES SHALL BE HUNG PLUMB AND SET SQUARE AGAINST THE WALL OR CEILING, OR SUSPENDED AS

THE MOUNTING HEIGHT OF LUMINAIRES SHALL BE CONFIRMED BEFORE INSTALLATION.

GENERAL ELECTRICAL NOTES

- THE MINIMUM WIRE SIZE SHALL BE 12 AWG. THE MINIMUM CONDUIT SIZE FOR HOMERUNS AND BRANCH FEEDS SHALL BE 3/4". ALL BRANCH CIRCUITS SHALL TERMINATE AT 20A. I-POLE CIRCUIT BREAKERS IN PANELBOARD INDICATED UNLESS OTHERWISE NOTED.
- 2. PROVIDE ALL PENETRATIONS, SLEEVES, AND SEALANT AS REQUIRED THROUGH PARTITIONS TO ACCOMMODATE THE FIRE ALARM, VOICE, AND DATA CABLING. ANY PENETRATIONS THROUGH WALLS AND FLOORS SHALL BE PROPERLY SEALED AND TREATED TO MAINTAIN THE FIRE STOPPING RATING OF THE WALLS, FLOORS AND CEILINGS.
- 3. BACKBOXES ARE TO BE MOUNTED OFFSET, NOT BACK TO BACK.
- 4. CIRCUIT NUMBER(S), WHERE SHOWN, ARE TO INDICATE QUANTITY OF CIRCUITS REQUIRED. VERIFY EXACT CIRCUIT NUMBER TO BE UTILIZED IN FIELD. CONTRACTOR SHALL PROVIDE ACTUAL CIRCUITING AS PART OF "AS BUILT" DRAWINGS.
- 5. UNLESS INDICATED OTHERWISE, MATERIALS REQUIRED TO PROVIDE BRANCH CIRCUITS AND FEEDERS ARE TO BE
- 6. DURING THE COURSE OF INVESTIGATION AND DEMOLITION, IF IT IS DETERMINED THAT IT MAY BE FEASIBLE TO UTILIZE EXISTING MATERIALS FOR BRANCH CIRCUITS AND FEEDERS, CONTRACTOR SHALL NOTIFY ENGINEER FOR APPROVAL PRIOR TO PERFORMING ANY WORK.
- ANY ELECTRICAL DEVICES ON WALLS SHALL BE FLUSH MOUNTED. NO WIREMOLDS ARE ACCEPTABLE UNLESS SPECIFICALLY INDICATED OTHERWISE
- 8. VERIFY RECEPTACLE LOCATIONS WITH ARCHITECTURAL FURNITURE LAYOUT TO ENSURE PROPER ACCESSIBILITY.
- LOW VOLTAGE CABLES SHALL NOT LAY ON TOP OF CEILING GRID SYSTEM. CABLES SHALL BE SUPPORTED AT INTERVALS NOT EXCEEDING 5 FEET UTILIZING J-HOOKS SUPPORTED BY STRUCTURAL MEMBERS. CABLES SHALL BE ROUTED PARALLEL OR PERPENDICULAR TO STRUCTURAL MEMBERS.
- 10. DRAWING DO NOT REPRESENT ALL EXISTING FIRE ALARM DEVICES. INITIATING AND NOTIFICATION DEVICES NOT SHOWN ON THE DRAWINGS ARE EXISTING TO REMAIN. IT IS THIS CONTRACTOR'S RESPONSIBILITY TO MAINTAIN OPERATION OF THE EXISTING DEVICES NOT SHOWN.
- EXISTING FIRE ALARM SYSTEM SHALL BE OPERATIONAL AT ALL TIMES. THE OCCUPIED AREA OF THE BUILDING SHALL NOT BE LEFT UNPROTECTED AT ANY TIME. IF AN INTERRUPTION OF FIRE ALARM SYSTEM IS REQUIRED TO FACILITATE DEVICE INSTALLATION, PROVIDE 48 HOURS OF ADVANCE NOTICE TO THE OWNER AND THE LOCAL FIRE DEPARTMENT, CONTRACTOR SHALL HIRE AN AUTHORIZED PERSONNEL TO WATCH/GUARD ANY UNPROTECTED AREAS OF THE BUILDING WHERE NECESSARY.
- 12. REMOVE AND REINSTALL CEILING MOUNTED DEVICES AS REQUIRED TO ALLOW INSTALLATION OF FEEDERS, BRANCH CIRCUITS, MECHANICAL PIPING AND DUCT WORK. DEVICES INCLUDE BUT ARE NOT LIMITED TO, LUMINAIRES, SPEAKERS, FIRE ALARM, AND PAGING DEVICES.
- 13. PROVIDE PULL BOX(ES) BETWEEN PULL POINTS AS REQUIRED TO COMPLY WITH NEC 344.26 THAT THERE SHALL NOT BE MORE THAN THE EQUIVALENT OF FOUR QUARTER BEND (360 DEGREE TOTAL) BETWEEN PULL POINTS.
- 14. SPECIAL ATTENTION SHALL BE PAID TO ALL CONDUIT ROUTING IN OPEN CEILING SPACE FOR AESTHETIC PURPOSES. ALL EXPOSED CONDUITS SHALL BE ROUTED PERPENDICULAR AND PARALLEL TO BUILDING LINES AND TIGHT TO CEILING/STRUCTURAL CORNERS. WHERE THIS IS NOT FEASIBLE, SUBMIT CONDUIT ROUTING PLAN TO ARCHITECT/ENGINEER FOR APPROVAL PRIOR TO INSTALLATION.
- 15. IN RENOVATIONS, IF AN EXISTING RECEPTACLE/JUNCTION BOX LOCATION WILL END UP HIDDEN BEHIND PERMANENTLY INSTALLED EQUIPMENT OR CASEWORK, PROCEED AS NOTED BELOW: A. IF THE RECEPTACLE IS AN END OF LINE DEVICE (IT DOES NOT FEED OTHER DEVICES), IT SHALL BE REMOVED INCLUDING ASSOCIATED WIRING BACK TO LAST ACTIVE DEVICE OR JUNCTION BOX AND A BLANK COVER PLATE INSTALLED. B. IF THE RECEPTACLE DOES SERVE DOWNSTREAM DEVICES, REMOVE RECEPTACLE AND REWORK WIRING TO A NEW OR EXISTING JUNCTION BOX ABOVE CEILING SUCH THAT NO WIRES ARE PRESENT IN THE JUNCTION BOX. A BLANK COVER PLATE SHALL BE INSTALLED.
- 16. CONTRACTOR SHALL PROVIDE DEDICATED NEUTRAL FOR EACH BRANCH CIRCUIT TO MEET THE REQUIREMENTS OF NEC ARTICLE 210.4(B).
- 17. PROVIDE BOND TO JUNCTION BOX FROM EQUIPMENT GROUNDING CONDUCTOR IN JUNCTION BOXES WHERE CURRENT CARRYING CONDUCTORS ARE SPLICED OR TERMINATED.
- 18. CONDUITS AND RACEWAYS SHALL NOT BE ROUTED ACROSS FLOORS OR SLABS.
- 19. IN AREAS OF THE BUILDING WHERE NEW CEILING HEIGHT IS HIGHER THAN THE EXISTING CEILING HEIGHT, ANY EXISTING CONDUITS/CONDUCTORS AND JUNCTION BOXES SERVING EXISTING DEVICES/EQUIPEMNT TO REMAIN SHALL BE RE-ROUTED, RELOCATED, AND MODIFIED AS REQUIRED TO ACCOMMODATE NEW CEILING HEIGHT. FIELD VERIFY EXACT CONDITIONS.
- 20. IN AREAS OF THE BUILDING WHERE NEW DRYWALL OR PLASTER CEILING IS SCHEDULED TO BE INSTALLED, ANY EXISTING JUNCTION BOXES AND ASSOCIATED CONDUITS/CONDUCTORS SHALL BE MODIFIED AND RELOCATED AS REQUIRED TO AN ACCESSIBLE LOCATION UNLESS NEW ACCESS PANELS ARE PERMITTED TO BE INSTALLED IN NEW CEILING BY THE ARCHITECT.
- 21. REFER TO MECHANICAL PLANS FOR EXACT LOCATIONS OF THERMOSTAT/CARBON DIOXIDE DETECTORS, PROVIDE SINGLE GANG BACKBOX AND EMPTY 3/4" CONDUIT WITH PULL STRING STUBBED INTO ACCESSIBLE CEILING SPACE FOR INSTALLATION OF THERMOSTAT/CARBON DIOXIDE DETECTORS. CABLING AND DEVICE SHALL BE BY OTHERS.
- 22. ALL LAY-IN LUMINAIRES SHALL BE INDEPENDENTLY SUPPORTED TO A STRUCTURAL MEMBER.
- 23. REFER TO ARCHITECTURAL FLOOR PLANS FOR ADDITIONAL INFORMATION REGARDING MOUNTING HEIGHTS AND LOCATIONS OF ELECTRICAL DEVICES BEFORE ROUGH-IN. WHERE CONFLICTS BETWEEN ELECTRICAL \$ ARCHITECTURAL ELEVATIONS ARISE, CONTRACTOR TO VERIFY WITH ARCHITECT/ENGINEER TEAM PRIOR TO ROUGH-IN.

GENERAL DEMOLITION NOTES

- ALL INDICATED ELECTRICAL EQUIPMENT, LUMINAIRES, DEVICES AND RELATED CONDUIT AND CONDUCTORS TO REMAIN UNLESS NOTED OTHERWISE.
- 2. ALL DEMOLITION OF THE ELECTRICAL SYSTEM AS NOTED ON THE DEMOLITION DRAWINGS SHALL BE COORDINATED WITH THE RENOVATION REQUIREMENTS TO DETERMINE THIS CONTRACTORS WORK.
- 3. IT IS THE INTENT OF THE ELECTRICAL DEMOLITION DRAWING(S) TO INDICATE AREAS IN WHICH ELECTRICAL EQUIPMENT, CONDUIT, LIGHTING FIXTURES, DEVICES, ETC. NEED TO BE REMOVED, RELOCATED OR MODIFIED BY THIS CONTRACTOR TO ALLOW FOR THE RENOVATION PHASE OF CONSTRUCTION. THE ELECTRICAL DEMOLITION PLAN IS FOR REFERENCE PURPOSES ONLY AND IT IS NOT INTENDED TO BE THE SOLE SOURCE OF EXISTING CONDITIONS.
- 4. CONTRACTOR SHALL VISIT THE BUILDING, BEFORE SUBMITTING HIS BID, TO VERIFY THE EXISTING CONDITIONS WHICH WILL AFFECT HIS WORK.
- CONTRACTOR SHALL BE RESPONSIBLE FOR THE COMPLETE ELECTRICAL DEMOLITION REQUIRED TO ACCOMMODATE THE RENOVATION. REMOVE AS REQUIRED ALL LIGHTING FIXTURES, CONNECTIONS TO MECHANICAL EQUIPMENT, DEVICES, ETC. PULL OUT ALL UNUSED CONDUCTORS AND CABLES AND REMOVE ALL ABANDONED CONDUIT. ELECTRICALLY DISCONNECT AIR HANDLING UNITS, PUMPS, BOILERS, AND OTHER SUCH EQUIPMENT FOR REMOVAL BY OTHERS. BACKFEED AS REQUIRED ALL DOWNSTREAM DEVICES WHICH REMAIN. THE CONTRACTOR SHALL COORDINATE WITH THE OWNER WHICH ITEMS INDICATED TO BE REMOVED \$ DISCONNECTED SHALL BE SALVAGED AND PRESENTED TO THE OWNER PRIOR TO ANY DISPOSAL OF THESE ITEMS.
- 6. ALL REMOVED EQUIPMENT SHALL BECOME THE PROPERTY OF THE CONTRACTOR AND SHALL BE REMOVED FROM THE SITE. WHERE WORK CALLED FOR ON THE DRAWINGS OR IN THE SPECIFICATIONS INVOLVES THE REMOVAL OF FLUORESCENT LAMPS CONTAINING MERCURY OR CLOTH INSULATED CONDUCTORS, THEY SHALL BE PROPERLY HANDLED AND REMOVED FROM SITE BY APPROVED METHODS PER EPA REGULATIONS.
- ALL EXISTING RECEPTACLES/DATA OUTLETS/EQUIPMENT ON WALLS THAT ARE NOT PART OF DEMOLITION SHALL REMAIN AS IS UNLESS NOTED OTHERWISE. CONTRACTOR SHALL CHECK AND VERIFY FOR CONTINUING OPERATION OF THESE DEVICES PRIOR TO SUBSTANTIAL COMPLETION. IF ANY EXISTING CIRCUITS TO REMAIN ARE INTERRUPTED BY DEMOLITION OR NEW CONSTRUCTION, CONTRACTOR SHALL BE RESPONSIBLE FOR REPLACEMENT/REMOVAL/REROUTING OF CONDUITS AND WIRES AS REQUIRED TO MAINTAIN FUNCTIONALITY OF DOWNSTREAM DEVICES AND EQUIPMENT.
- 8. THE CONTRACTOR SHALL COORDINATE WITH THE THE PROJECT PHASING AND MAINTAIN EXISTING SYSTEMS ACTIVE IN AREAS WHICH REMAIN OCCUPIED.
- 9. EXISTING CEILING MOUNTED SPEAKERS, PROGRAM BELLS, FIRE ALARM DEVICES AND SIMILAR ELECTRICAL EQUIPMENT AND DEVICES TO REMAIN SHALL BE EXTENDED AND REINSTALLED AS REQUIRED IN NEW CEILINGS. FIELD VERIFY EXACT QUANTITIES AND REQUIREMENTS.
- 10. SUPPORT ALL CABLING DRAPED OR LAYING LOOSE ABOVE EXISTING CEILINGS WHICH ARE SCHEDULED TO BE REMOVED. TIE WRAP CABLING TO JOISTS OR OTHER STRUCTURAL MEMBERS AS REQUIRED. UPON THE COMPLETION OF THE PROJECT, NO WIRING/CABLING SHALL BE LAYING ON THE ACCESSIBLE CEILINGS.
- WHERE EXISTING DEVICE IS REMOVED FROM WALL WITH NO NEW DEVICE GOING BACK AT SAME LOCATION, PROVIDE BLANK BRUSHED STAINLESS STEEL COVER PLATES AS REQUIRED. COVER PLATES SHALL BE OF PROPER SIZE AND INSTALLED FLUSH WITH WALL

GENERAL NOTES

- PENETRATIONS. ANY PENETRATIONS THROUGH WALLS AND FLOORS SHALL BE PROPERLY SEALED AND TREATED TO MAINTAIN THE FIRE STOPPING RATING OF THE WALL. CABLING SHALL NOT PENETRATE WALLS UNLESS ROUTED THROUGH RACEWAY SYSTEM OR ROUTED ABOVE ACCESSIBLE CEILINGS THROUGH METALLIC CONDUIT SLEEVES, EXTENDING A MINIMUM OF 6" EACH SIDE OF THE WALL WITH PROTECTIVE END BUSHINGS TO PREVENT DAMAGE TO CABLES. VOIDS AROUND SLEEVES SHALL BE SEALED WITH APPROPRIATE MATERIALS AS TO MAINTAIN THE ACOUSTIC OR FIRE RATING OF WALLS ABOVE AND BELOW CEILINGS. CABLES RAN THROUGH VOIDS WITHOUT SLEEVES OR RACEWAYS WILL NOT BE ACCEPTABLE. CONTRACTOR SHALL VERIFY EXISTING FIRE PARTITIONS IN THE FIELD.
- ALARM, ELECTRICAL, OR OTHER SYSTEMS. SUCH INCIDENTAL WORK IS ALSO PART OF THIS CONTRACT. INSPECT THOSE AREAS, ASCERTAIN WORK NEEDED, AND DO THAT WORK IN ACCORD WITH THE CONTRACT REQUIREMENTS, AT NO ADDITIONAL COST. THE REMOVAL & REINSTALLATION OF EXISTING WORK TO ACCOMMODATE CHANGES TO EXISTING, OR INSTALLATION OF, ELECTRICAL, OTHER SYSTEMS IS ALSO PART OF THIS CONTRACT
- EXISTING CONDITIONS WERE OBTAINED FROM EXISTING AS-BUILT DRAWINGS AND
- . REFER TO ARCHITECTURAL FLOOR PLANS FOR ADDITIONAL INFORMATION REGARDING MOUNTING HEIGHTS AND LOCATIONS OF ELECTRICAL DEVICES BEFORE ROUGH-IN. WHERE CONFLICTS BETWEEN ELECTRICAL \$ ARCHITECTURAL ELEVATIONS ARISE, CONTRACTOR


BIDDING NOTE

SEE DRAWING MEI.O FOR GENERAL NOTES AND ADDITIONAL DETAILS APPLICABLE TO THIS TRADE'S

STEEL CABLE SUPPORT. TIE TO STRUCTURAL MEMBER. - FLEXIBLE CONNECTION TO JUNCTION BOX JUNCTION BOX -WHERE CONDUCTORS SUPPORT BAR ARE IN CONDUIT. 6" CONDUIT STUB OR CABLE GROMMET WITH LOW VOLTAGE - CEILING MOUNTED └CEILING GRID SYSTEM CABLES WHERE CONDUCTORS ARE DEVICE. OPEN AIR ABOVE ACCESSIBLE CEILING.

CEILING MOUNTED DEVICE SUPPORT DETAIL

NO SCALE

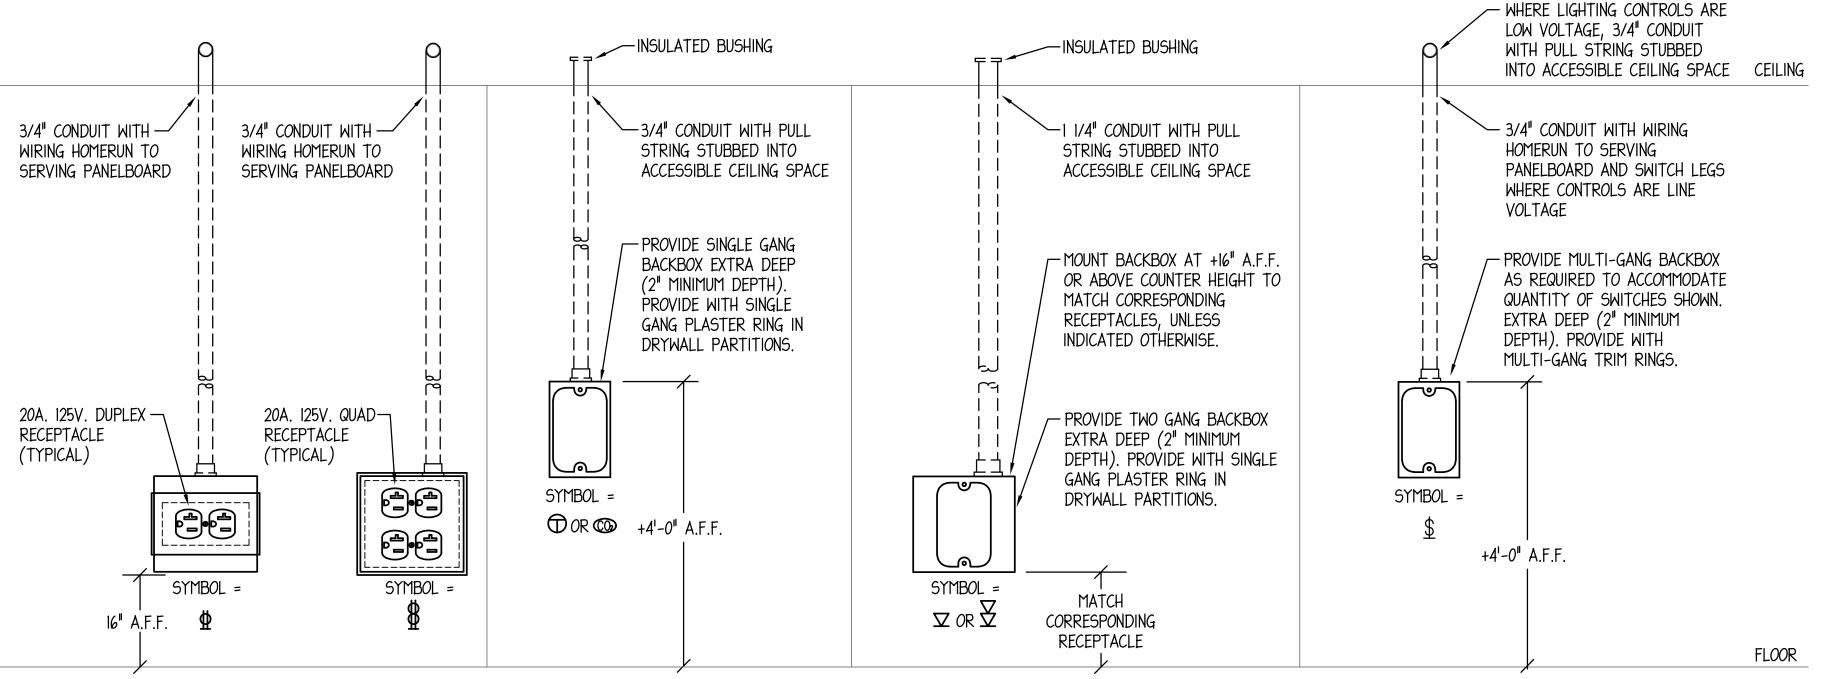

JUNCTION BOX ROUGH-IN DETAIL

- DETAILS ARE FOR REFERENCE ONLY.
- NOT ALL DEVICES ARE REQUIRED FOR THIS PROJECT.

PROVIDE TWO GANG BACKBOXES (2" MINIMUM DEPTH) WITH ALL RECEPTACLE OUTLETS.

- CONTRACTOR SHALL MAINTAIN FIRE RATING OF ALL PARTITIONS FOR NEW
- . INCIDENTAL WORK MAY ALSO BE NECESSARY DUE TO CHANGES AFFECTING, FIRE
- CURSORY FIELD OBSERVATION. CONTRACTOR SHALL IDENTIFY ANY DISCREPANCIES IN THE FIELD AND REPORT THEM TO THE ENGINEER.
- TO VERIFY WITH ARCHITECT/ENGINEER TEAM PRIOR TO ROUGH-IN.

SHEET TITLE:

KEY PLAN:

SHEET STATUS:

ISSUED FOR BID - NOT

FOR CONSTRUCTION

DESCRIPTION:

ELECTRICAL DETAILS, NOTES AND

ARCHITECT OF RECORD

CHICAGO, IL 60661 P: 312.496.0000

MEP-FP ENGINEER

1216 TOWER ROAD

P: 847.882.2010

SCHAUMBURG, IL 60173

DEMONICA KEMPER ARCHITECTS

20/10 ENGINEERING GROUP, LLC

125 N. HALSTED STREET, SUITE 301

SPECIFICATIONS SHEET NUMBER:

04/25/2024