
MCHENRY COUNTY COLLEGE PLAYGROUND RECONSTRUCTION DOCUMENTS


MCHENRY COUNTY COLLEGE CRYSTAL LAKE, ILLINOIS 2020

PROJECT CONTACTS

OWNER: McHENRY COUNTY COLLEGE 8900 U.S. HICHWAY 14 CRYSTAL LAKE, ILLINOIS 60014 PHONE: (815) 455–8585 MR. TODD WHEELAND — ASSISTANT VICE PRESIDENT OF FACILITIES MANAGEMENT LANDSCAPE ARCHITECT: HR GREEN, INC. 420 NORTH FRONT STREET, SUITE 100 MCHENRY, IL 60050 PHONE: (815) 385–1778 DAVID L. REITZ, P.LA. — PROJECT MANAGER

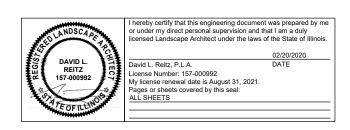

LOCATION MAP

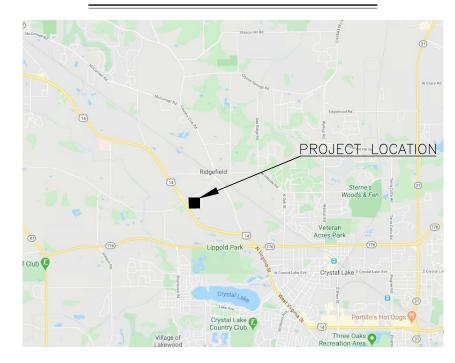



420 N. FRONT STREET, SUITE 100 | McHENRY, IL 60050
Phone: 815.385.1778 | Toll Free: 800.728.7805 | Fax: 815.385.1781 | HRGreen.com

SHEET INDEX

SHE	ET INDEX	
She	et Number	Sheet Title
G.00)	COVER SHEET
G.01	1	GENERAL NOTES
C.01	1	EXISTING CONDITIONS & DEMOLITION PLAN
C.02	2	LAYOUT & DIMENSIONING PLAN
C.03	3	LAYOUT & GRADING PLAN
C.04	4	DETAILS
C.05	5	DETAILS
L.01		LANDSCAPE PLAN
L.02	2	LANDSCAPE DETAILS

SITE BENCHMARKS:

SITE BENCHMARK 1
CUT CROSS IN CONCRETE CURB
ELEV=917.65 (NAVD 88)



FOR BID

DID

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 NRS
 JOB DATE:
 2020
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 APPROVED:
 JFV
 JOB NUMBER:
 191714
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NO. DATE BY REVISION DESCRIPTION



PLAYGROUND RECONSTRUCTION DOCUMENTS
McHENRY COUNTY COLLEGE
CRYSTAL LAKE, ILLINOIS

GENERAL

COVER SHEET

SHEET NO.

SITE/CIVIL GENERAL NOTES:

- ALL ITEMS OF THIS PROJECT SHALL BE GOVERNED BY SPECIFICATIONS INCLUDED IN THE DOCUMENTS LISTED BELOW:
- A. "STANDARD SPECIFICATIONS FOR ROAD AND BRIDGE CONSTRUCTION" PREPARED BY THE ILLINOIS DEPARTMENT OF TRANSPORTATION AND ADOPTED BY SAID DEPARTMENT (LATEST REVISION).
- B. "SUPPLEMENTAL SPECIFICATIONS AND RECURRING SPECIAL PROVISIONS" ADOPTED BY THE ILLINOIS DEPARTMENT OF TRANSPORTATION (LATEST REVISION).
- C. "STANDARDS AND SPECIFICATIONS FOR SOIL EROSION AND SEDIMENT CONTROL" (LATEST REVISION)
- D. "STANDARD SPECIFICATIONS FOR WATER AND SEWER MAIN CONSTRUCTION IN ILLINOIS" (LATEST REVISION).
- 2. BASE MAP INFORMATION IS ACCURATE AS OF THE DATE PRINTED ON THIS PACKAGE. AS-BUILT/BASE MAP SURVEY INFORMATION WAS COLLECTED IN DECEMBER 2019.
- 3. NO DIMENSIONS SHALL BE ASSUMED BY SCALING.
- 4. ALL SEDIMENTATION AND EROSION CONTROL REGULATIONS SHALL BE ADHERED TO PER CITY OF CRYSTAL LAKE, THE STATE OF ILLINOIS AND THE FEDERAL GOVERNMENT REQUIREMENTS.
- 5. AREAS TO BE FILLED SHALL BE MONITORED BY A TESTING SERVICE FOR MATERIAL COMPOSITION AND COMPACTION (COLLEGE
- 6. ALL TOPSOIL SHALL BE STRIPPED PRIOR TO FILLING, CONTRACTOR TO STOCKPILE TOPSOIL AS NEEDED IN A LOCATION AS COORDINATED WITH THE ENGINEER, EXCESS TOPSOIL WILL BE PAID FOR AS REMOVAL AND DISPOSAL OF UNSUITABLE MATERIAL,
- 7. EXISTING UTILITIES, TREES, OTHER LANDSCAPING, STRUCTURES, AND PAVEMENT LOCATIONS SHOWN ARE APPROXIMATE. CONTRA SHALL FIELD VERIFY THE EXACT LOCATIONS OF THESE OR ANY OTHER EXISTING FACILITIES AS REQUIRED FOR COMPLETION OF PROJECT.
- 8. WHERE EXISTING UTILITY FIXTURES ARE SHOWN AS EXISTING ON THE PLANS OR ENCOUNTERED WITHIN THE CONSTRUCTION AREA, IT SHALL BE THE RESPONSIBILITY OF THE CONTRACTOR TO NOTIFY THE ENGINEER OF THOSE UTILITIES PRIOR TO BEGINNING CONSTRUCTION. THE CONTRACTOR SHALL ALLOW ACCESS TO THESE FACILITIES FOR NECESSARY MODIFICATION OF SERVICES. UNDERGROUND FACILITIES, STRUCTURES, AND UTILITIES HAVE BEEN PLOTTED FROM AVAILABLE SURVEYS AND RECORDS, AND THEREFORE THEIR LOCATIONS MUST BE CONSIDERED APPROXIMATE ONLY. IT IS POSSIBLE THERE MAY BE OTHERS, THE EXISTENCE OF WHICH IS NOT KNOWN OR SHOWN, IT IS THE CONTRACTORS RESPONSIBILETY TO DETERMINE THEIR EXISTENCE AND THE EXACT LOCATIONS OF THESE UTILITIES AND PREVENT DAMAGE THERETO. NO CLAIMS FOR ADDITIONAL COMPENSATION SHALL BE ALLOWED TO CONTRACTOR ANY INTERFERENCE OR DELAY CAUSED BY SUCH WORK. THE CONTRACTOR SHALL BE RESPONSIBLE FOR BECOMING AWARE OF AND FIELD VERIFYING ALL RELATED EXISTING AND PROPOSED CONDITIONS, UTILITIES, PIPES AND STRUCTURES, ETC. PRIOR TO BIDDING AND CONSTRUCTION. THE CONTRACTOR SHALL BE REPORTED FOR CONTRACTOR STALL, ET, THE MUNICIPAL PUBLIC WORKS DEPARTMENT, THE COUNTRACTOR SHALL BE REPORTED FOR CONTRACTOR SHALL, THE MUNICIPAL PUBLIC WORK SEPARTMENT, THE CONTRACTOR SHALL NOTIFY THE ENGINEER OF APPARENT CONTLICTION. THE CONTRACTOR SHALL NOTIFY THE ENGINEER OF APPARENT CONTLICTION. THE CONTRACTOR SHALL NOTIFY THE ENGINEER OF APPARENT CONCILICITS WITH CONSTRUCTION AND UTILITIES SO THAT ADJUSTMENTS CAN BE PLANNED PRIOR TO INSTALLATION. IF FIELD ADJUSTMENTS ARE NECESSARY DUE TO EXISTING UTILITY LOCATIONS THEY MUST BE APPROVED BY THE ENGINEER OF THE CONTRACTOR SHALL THE CONTRACTOR SHALL THE CONTRACTOR SHALL TO THE CONTRACTOR SHALL THE CONTRACTOR SHALL TO SET THE CONTRACTOR SHALL THE CONTRACTOR SHALL TO SET THE CONTRACTOR SHALL THE CONTRACTOR SHALL TO SET THE CONTRACTOR SHALL TO SET THE CONTRACTOR SHALL THE CONTRACTOR SHALL THE CONTRACTOR SHALL THE CONTRACTOR SHALL COSTS OR OTHER LIABILITIES INCURRED DUE TO DAMAGE OF SAID UTILITIES/STRUCTURES/ETC.
- 9. IT IS THE CONTRACTOR'S RESPONSIBILITY TO ASCERTAIN EXISTING FIELD CONDITIONS PRIOR TO BIDDING ON THE PROJECT
- 10. THE CONTRACTOR SHALL APPLY FOR AND PROCURE ALL REQUIRED PERMITS PRIOR TO COMMENCING WORK
- 11. THE CONTRACTOR SHALL COMPLY WITH ALL CODES APPLICABLE TO THIS WORK.
- 12. THE CONTRACTOR SHALL STAKE ALL IMPROVEMENTS AS NOTED ON THE FOLLOWING PLANS, AS WELL AS, TREE LOCATIONS AND THE PERIMETER OF SHRUB/PERENNIAL BEDS PRIOR TO INSTALLATION AND CONTACT THE ENGINEER FOR APPROVAL PRIOR TO EXCAVATING THE FOUNDATIONS AND FOOTINGS, FINAL LOCATION AND STAKING OF ALL IMPROVEMENTS SHALL BE ACCEPTED BY THE ENGINEER IN ADVANCE OF INSTALLATION.
- 13. SEE LANDSCAPE PLAN FOR PROPOSED SITE RESTORATION.
- 14. ALL DISTURBED AREAS TO BE RESTORED W/ 4" TOPSOIL RESPREAD & SOD UNLESS OTHERWISE NOTED ON PLANS.
- 15. ALL PROPOSED UTILITY SERVICE (SANITARY, WATER & ELECTRICAL) LOCATIONS TO BE VERIFIED PRIOR TO CONSTRUCTION.
- 16. CONTRACTOR SHALL VERIFY PROJECT COMPLIES WITH ALL ADAAG GUIDELINES.
- 17. THE CONTRACTOR WILL BE RESPONSIBLE FOR ALL SITE MAINTENANCE DURING THE PERIOD OF CONSTRUCTION. CONTRACTOR SHALL KEEP THE SITE CLEAN.
- 18. ALL UNDERGROUND ELECTRICAL WORK SHALL BE COORDINATED WITH THE ELECTRIC COMPANY AND COORDINATED IN A TIMELY
- 19. CONSTRUCTION ACTIVITIES SHALL BE SCHEDULED TO ALLOW FOR COMPLETION OF THE LANDSCAPING WORK WITHIN THE SUBSTANTIAL COMPLETION DATE (JUNE 30TH). LANDSCAPING PERFORMED OUTSIDE OF THE SUBSTANTIAL COMPLETION TIMEFRAME MUST BE APPROVED BY OWNER.

TRAFFIC CONTROL & STAGING NOTES:

- 1. THE CONTRACTOR SHALL EMPLOY SOUND PRACTICES OF SAFETY AND TRAFFIC CONTROL.
- 2. STAGING AREA SHALL BE THE ACCESS DRIVE EAST OF THE IMPROVEMENTS. THE CONTRACTOR SHALL COORDINATE WITH THE OWNER TO CONFIRM STAGING LOCATION PRIOR TO THE START OF CONSTRUCTION.
- 3. CONTRACTOR IS RESPONSIBLE FOR RESTORING THE STAGING AREA BACK TO ACCEPTABLE/IT'S ORIGINAL CONDITION. INCLUDING GRADING, GROUND COVER CONDITION, ETC. THE PROPERTY SHALL BE MADE EQUAL TO OR BETTER THAN THE EXISTING SITE CONDITION PRIOR TO CONSTRUCTION STAGING.

SITE DESCRIPTION:

THE FOLLOWING IS A DESCRIPTION OF THE CONSTRUCTION ACTIVITY WHICH IS THE SUBJECT OF THIS PLAN: CHILDREN'S LEARNING CENTER — OUTDOOR PLAY AREA RECONSTRUCTION.

- THE PROPOSED DEVELOPMENT CONSISTS OF CONSTRUCTION OF AN OUTDOOR PLAY AREA. THE CONSTRUCTION ACTIVITIES FOR SITE IMPROVEMENTS WILL INCLUDE: DEMOLITION, CONCRETE FLATWORK, CONCRETE STAINING, PLAYGROUND EQUIPMENT, SHADE STRUCTURE, UNDERDRAIN, FENCING, LANDSCAPING, MINOR GRADING AND TURF RESTORATION.
- 2. THE FOLLOWING IS A DESCRIPTION OF THE INTENDED SEQUENCE OF MAJOR ACTIVITIES WHICH WILL DISTURB SOILS FOR MAJOR PORTIONS OF THE CONSTRUCTION SITE SUCH AS EXCAVATION, AND GRADING:

THE SEQUENCE OF THE CONSTRUCTION ACTIVITIES MAY BE AS FOLLOWS: 1) INSTALL NECESSARY EROSION CONTROL MEASURES AND CONSTRUCTION FENCING. 2) DEMOLITION / CLEARING AND GRUBBING. 3) TOPSOIL STRIPPING. 4)UNDERGROUND UTILITIES INSTALLATION. 5) GRADING, 6) HARDSCAPE IMPROVEMENT INSTALLATIONS. 7) FINE GRADING, PLANTING AND SODDING. THE SOIL EROSION AND SEDIMENTATION CONTROL ITEMS WILL BE INSTALLED AS NEEDED DURING THE ABOVE CONSTRUCTION ACTIVITIES.

EROSION CONTROL NOTES:

- 1. SITE GRADING SHALL NOT PROCEED UNTIL EROSION CONTROL MEASURES HAVE BEEN INSTALLED
- 2. ALL SIDEWALKS, STREETS AND DRIVEWAYS MUST BE KEPT CLEAN AT ALL TIMES.

- 3. PROVIDE EROSION CONTROL MEASURES AROUND TOPSOIL STOCKPILES AS NECESSARY TO PREVENT EROSION. PAID FOR AS PERIMETER
- 4. CONTRACTOR SHALL BE RESPONSIBLE FOR THE REMOVAL OF SILT FENCING, INLET PROTECTION AND OTHER EROSION CONTROL MEASURES ONCE THE WORK IS COMPLETED AND THE SITE HAS BEEN STABILIZED TO 70% VEGETATIVE COVERAGE MINIMUM.
- 5. IF ANY ADDITIONAL SOIL EROSION MEASURES ARE DEEMED NECESSARY BY THE ENGINEER, THESE MEASURES MUST BE IMMEDIATELY IMPLEMENTED BY THE CONTRACTOR.

EROSION CONTROL SEQUENCE NOTES:

- 1. INSTALL EROSION CONTROL MEASURES AND SILT FILTER FENCE AS NECESSAR'
- 2. STRIP AND STOCKPILE TOPSOIL, STABILIZE STOCKPILES WITHIN 7 DAYS.
- 3. CONTINUE GRADING, STABILIZE COMPLETED AREAS WITH PERMANENT STABILIZATION OR INACTIVE AREAS WITH TEMPORARY STABILIZATION
- 4. INSTALL UTILITIES
- 5. COMPLETE GRADING.
- 6. INSTALL HARDSCAPE IMPROVEMENTS
- 7. INSTALL PERMANENT SODDING AND PLANTINGS.
- 8. WHEN ALL CONSTRUCTION ACTIVITY IS COMPLETE AND THE SITE IS STABILIZED, RE-SOD ANY REMAINING DISTURBED AREAS.
- 9. REMOVE ALL TEMPORARY EROSION CONTROL MEASURES ONCE VEGETATION REACHES 70% COVERAGE.

GRADING CONSTRUCTION NOTES:

- 1. NO SUB-SURFACE EXPLORATION DATA HAS BEEN COLLECTED FOR THIS PROJECT. GEO-TECHNICAL SERVICES AND SOIL BORING LOGS
- 2. CONTRACTOR SHALL CUT AND FILL SITE AS REQUIRED TO OBTAIN FINISHED ELEVATIONS SHOWN ON PLANS. COMPACT SELECT BACKFILL MATERIAL TO 95% STANDARD PROCTOR DENSITY AS PER ASTM D-698. ALL REQUIREMENTS OF PROJECT SPECIFICATIONS FOR EARTHWORK SHALL BE MET.
- 3. CONTRACTOR TO PROVIDE TEMPORARY MEASURES TO CONTROL STORM WATER RUN-OFF DURING CONSTRUCTION AS REQUIRED TO MINIMIZE EROSION.
- 4. THE FILL SHALL BE PLACED IN LOOSE LIFTS NOT EXCEEDING 8—INCHES AND COMPACTED TO 95% OF MAXIMUM DRY DENSITY AS DETERMINED BY ASTM D-698. THE MOISTURE CONTENT FOR COMPACTION OF THE SITE FILL SHALL BE AS DETERMINED BY THE SOILS ENGINEER.

CONSTRUCTION NOTES:

- 1. CONTRACTOR SHALL NOTIFY THE ENGINEER 48 HOURS PRIOR TO COMMENCEMENT OF WORK TO COORDINATE INSPECTION SCHEDULES.
- SUBSTITUTIONS ARE THE RESPONSIBILITY OF THE CONTRACTOR AND SHALL BE SUBMITTED TO THE ENGINEER FOR APPROVAL.
- 3. THE CONTRACTOR SHALL COORDINATE THE STORING OF MATERIALS, PARKING OF VEHICLES AND RESTRICTIONS OF WORK AND ACCESS WITH THE OWNER.
- 4. ALL CONSTRUCTION COVERED BY THESE CONTRACT DOCUMENTS SHALL BE IN CONFORMANCE WITH THE LATEST EDITION OF ALL APPLICABLE CITY, COUNTY, AND OSHA CODES AND STANDARDS INCLUDING BUT NOT LIMITED TO THE UNIFORM BUILDING CODE, ENACTED BY THE CONFERENCE OF BUILDING OFFICIALS, MOST RECENT EDITION, AND AMENDMENTS AS ADOPTED BY LOCAL GOVERNMENT.
- 5. THE CONTRACTOR SHALL PROVIDE ALL LABOR, EQUIPMENT, MATERIALS, AND SUPERVISION NECESSARY TO ACCOMPLISH THE WORK AS SHOWN AND NOTED ON THE DRAWINGS UNLESS OTHERWISE NOTED.
- 6 CONTRACTORS AND SUBCONTRACTORS ARE RESPONSIBLE FOR REMOVAL OF TRASH AND REPAIR OF HAZARDOUS CONDITIONS (LE
- 7. UPON COMPLETION OF CONSTRUCTION AND PRIOR TO FINAL APPROVAL, CONTRACTOR SHALL THOROUGHLY CLEAN UP THE PROJECT SITE AND REMOVE ALL TRASH, SCRAPS, BRICK, ROCKS, MORTAR, ETC. REPAIR ALL DAMAGE TO FINISH GRADES INCLUDING TAILINGS FROM EXCAVATIONS, WHEEL RUTS, OR ANY SETTLING OR EROSION OCCURRING PRIOR TO COMPLETION.
- 8. THE CONTRACTOR SHALL BE FULLY RESPONSIBLE FOR ANY DAMAGE TO EXISTING ELECTRICAL, WATER, WASTEWATER, STORM WATER LINES AND TRAFFIC CONTROL DEVICES. ETC. ALL DAMAGES SHALL BE REPAIRED IN ACCORDANCE WITH THE GOVERNING AUTHORITY, AT NO COST TO THE OWNER.
- 9. ADEQUATE DRAINAGE SHALL BE MAINTAINED AT ALL TIMES DURING CONSTRUCTION. THE DRAINAGE INCLUDES SURFACE AND GROUND WATER. ANY DRAINAGE DITCH OR STRUCTURE DISTURBED DURING CONSTRUCTION SHALL BE RESTORED TO THE SATISFACTION OF THE OWNING ALITHORITY
- 10. CONTRACTOR SHALL TAKE NECESSARY PRECAUTIONS TO PROTECT ROOT SYSTEMS OF SHRUBS, PLANTS AND TREES ALONG THE AREA OF EXCAVATION. THIS SHALL BE PAID FOR AS TEMPORARY FENCE AND TREE ROOT PRUNING.
- 11. IT SHALL BE THE CONTRACTOR'S RESPONSIBILITY TO PROVIDE APPROVED WASTE AREAS OR DISPOSAL SITES FOR EXCESS MATERIAL WHICH IS NOT DESIRABLE TO BE INCORPORATED INTO THE WORK INVOLVED WITH THIS PROJECT. WASTE MATERIALS INCLUDING PAVEMENT REMOVED DURING CONSTRUCTION, MASONRY WALLS, CONCRETE, CONSTRUCTION DEBRIS AND EXCESS EXCAVATED MATERIAL SHALL BECOME THE PROPERTY OF THE CONTRACTOR AND SHALL BE REMOVED FROM THE PROJECT SITE AND DISPOSED OF PROPERLY BY THE CONTRACTOR IS RESPONSIBLE TO ACQUIRE ANY PERMIT REQUIRED FOR SUCH DISPOSAL. WASTE MATERIAL MUST BE REMOVED FROM SITE PRIOR TO INITIAL INSPECTION AND ACCEPTANCE. BURNING ON THE SITE WILL NOT BE PERMITTED. NO SOLID MATERIALS, INCLUDING BUILDING MATERIALS, SHALL BE DISCHARGED INTO WATERS OF THE STATE.
- 12 DURING REMOVAL AND CONSTRUCTION THE CONTRACTOR SHALL USE ALL MEANS NECESSARY TO CONTROL DUST SPREADING FROM ALL WORK AND STAGING AREAS. DUST CONTROL MEASURES SHALL BE IN ACCORDANCE WITH ARTICLE107.36 SPECIFICATIONS AND APPROVED BY THE ENGINEER.
- 13. SURFACE RESTORATION: AT THE END OF ALL CONSTRUCTION PROJECTS THE CONTRACTOR SHALL RESTORE THE EXISTING FACILITIES AND ALL SPOIL MATERIAL, VEGETATION, AND DEBRIS SHALL BE HAULED AND DISPOSED OF OFF SITE. THE PROPERTY SHALL BE MADE EQUAL TO OR BETTER THAN THE EXISTING SITE CONDITION PRIOR TO CONSTRUCTION.
- 14. FINAL APPROVAL OF GRADES IN GRASS AREAS AND SWALES SHALL BE APPROVED BY THE ENGINEER PRIOR TO INSTALLATION OF LANDSCAPING MATERIALS TO ENSURE POSITIVE DRAINAGE.


LANDSCAPING GENERAL NOTES:

- 1. THE LANDSCAPE PLANS CONTAINED HEREIN ILLUSTRATE APPROXIMATE LOCATIONS OF ALL SITE CONDITIONS.
- 2. THE CONTRACTOR SHALL BE RESPONSIBLE FOR COORDINATION WITH SUBCONTRACTORS AND OTHER CONTRACTORS OF RELATED TRADES, AS REQUIRED, TO ACCOMPLISH THE PLANTING AND RELATED OPERATIONS.
- 3. THE CONTRACTOR SHALL COORDINATE INSTALLATION OF ALL PLANT MATERIAL WITH THE INSTALLATION OF OTHER IMPROVEMENTS SUCH AS HARDSCAPE ELEMENTS AND RELATED STRUCTURES. ANY DAMAGE TO EXISTING IMPROVEMENTS IS THE RESPONSIBILITY OF THE
- 4. THE CONTRACTOR IS RESPONSIBLE TO RESTORE ALL AREAS OF THE SITE, OR ADJACENT AREAS, WHERE DISTURBED BY OPERATIONS OF OR RELATED TO THE CONTRACTOR'S WORK, ANY DAMAGE TO EXISTING IMPROVEMENTS IS THE RESPONSIBILITY OF THE
- ALL SURFACE DRAINAGE SHALL BE DIVERTED AWAY FROM STRUCTURES AND NOTED SITE FEATURES IN ALL AREAS AS SHOWN ON THE GRADING PLANS. ALL AREAS SHALL POSITIVELY DRAIN.
- 6. IF CONFLICTS ARISE BETWEEN THE SIZE OF AREAS AND PLANS, THE CONTRACTOR IS REQUIRED TO CONTACT THE ENGINEER FOR RESOLUTION PRIOR TO INSTALLATION.
- 7. ALL PLANTS SHALL BE NURSERY GROWN PLANTS MEETING AMERICAN NURSERY AND LANDSCAPE ASSOCIATION (ANLA) STANDARDS SET FORTH IN THE "AMERICAN STANDARD FOR NURSERY STOCK" (ANSI Z60.1-LATEST EDITION). PLANTS ARE TO BE TYPICAL IN SHAPE AND SIZE FOR SPECIES. PLANTS PLANTED IN ROWS OR GROUPS SHALL BE MATCHED IN FORM. PLANT MATERIAL OF THE SAME SPECIES SHALL BE OBTAINED FROM THE SAME SOURCE, PLANTS SHALL NOT BE ROOT-BOUND OR LOOSE IN THEIR CONTAINERS. HANDLE ALL PLANTS WITH CARE IN TRANSPORTING, PLANTING AND MAINTENANCE UNTIL INSPECTION AND FINAL ACCEPTANCE. FIELD COLLECTED MATERIAL SHALL NOT BE USED UNLESS APPROVED BY THE ENGINEER
- 8. ALL PLANTING BED EDGES TO BE SHOVEL CUT.
- AREAS DESIGNED TO RECEIVE SOLID SOD SHALL BE APPROVED BY THE ENGINEER PRIOR TO GRASSING OPERATIONS. FINISH GRADE AT TURF AREAS SHALL BE 3/4"-1" BELOW TOP OF ADJACENT PAVEMENT OR CURBS.
- 10. MUSHROOM COMPOST SHALL BE FINELY SCREENED, HOMOGENOUS, DECOMPOSED ORGANIC MATERIAL SUITABLE FOR HORTICULTURAL USE. MIX THOROUGHLY IN PLANT BED BEFORE INSTALLING PLANTS.



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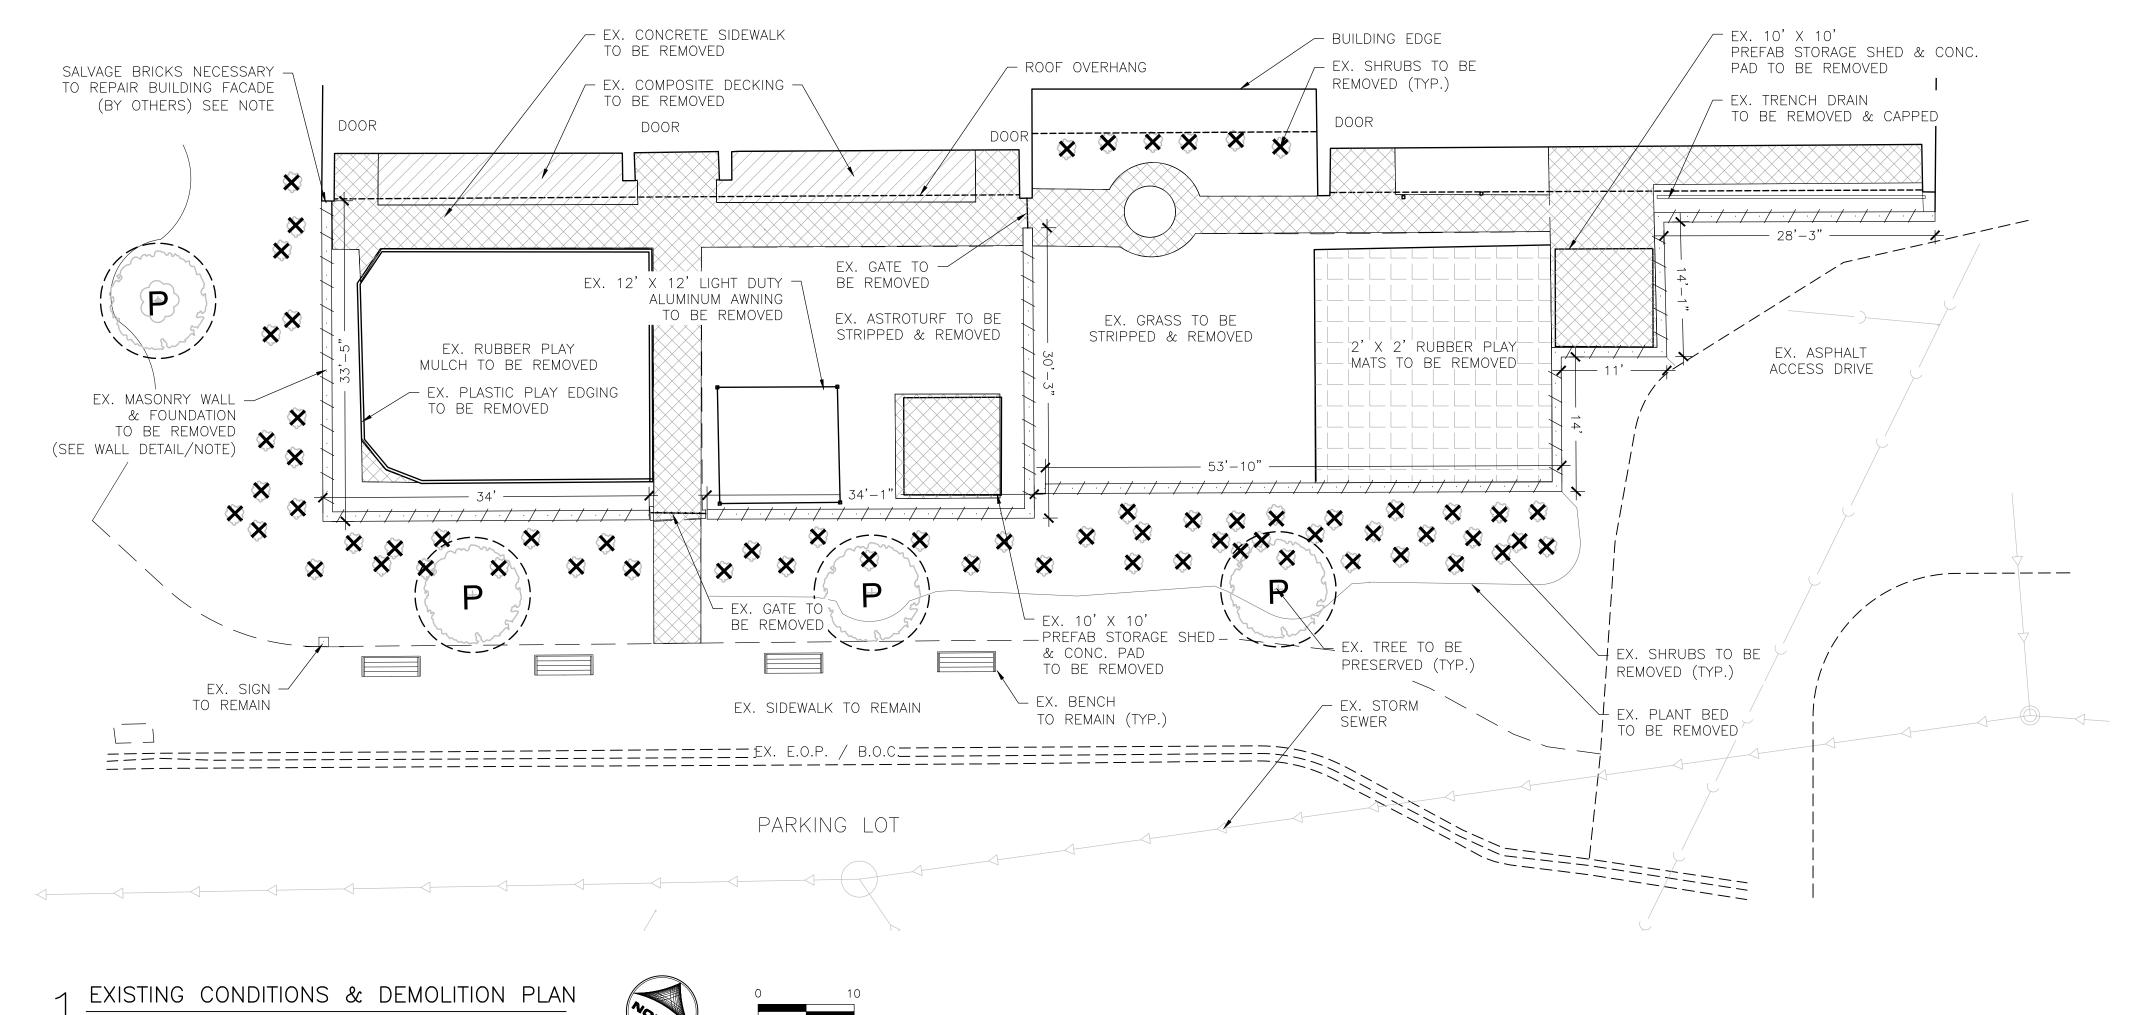
PLAYGROUND RECONSTRUCTION DOCUMENTS McHENRY COUNTY COLLEGE CRYSTAL LAKE. ILLINOIS

GENERAL NOTES

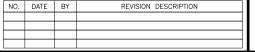
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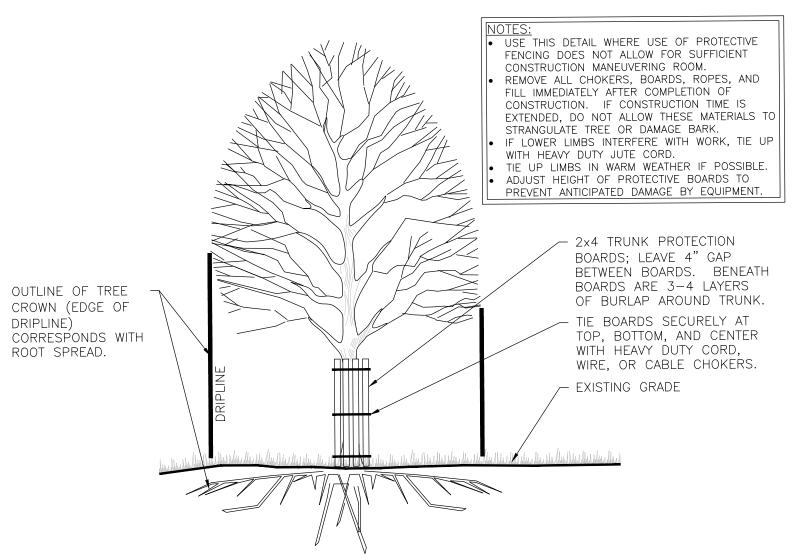
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TREE PROTECTION KEY EXIST. TREE TO BE PRESERVED ----- CRITICAL ROOT ZONE TOTAL QUANTITIES (IN VICINITY OF DISTURBANCE AND PROPOSED IMPROVEMENTS) EXIST. TREES TO BE PRESERVED EXIST. TREES TO BE REMOVED TOTAL EXISTING TREES TAGGED

GENERAL NOTES

1. THE INTENT IS TO KEEP THE EXISTING TREES TO BE PRESERVED IN TACT THROUGHOUT THE DURATION OF CONSTRUCTION ON-SITE. IF THE TREES ARE DAMAGED DURING CONSTRUCTION, THE CONTRACTOR IS RESPONSIBLE FOR REPLACING TREES EQUAL IN CALIPER.



TYP. TREE TRUNK PROTECTION DETAIL

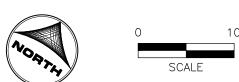-PRE-FINISHED SHT. MTL, CAP. -CONT. CLEAT- TYP. BOTH SIDES. TREATED 2x WD. ONTO HT BLOCKING - ANCHOR TO GROUT FILLED CHU CORES@ 24" O.C. W/1/2" COLANTER SUIK ANCHOR BOLTS HORIZ, WALL TIES Ø IL'O.C. VERT. 4 PACEBRICK (TYP: BOTH SIDES - 4" CMU. - EXIST. FOUNDATIONS WHEN HOLES QUE OF

NOTES:

- 1. CONTRACTOR TO REMOVE AND DISPOSE OF ALL ITEMS WITHIN THE PLAY AREA AS NOTED ON
- 2. CONTRACTOR RESPONSIBLE FOR ALL CLEARING AND GRUBBING.
- 3. CONTRACTOR TO SALVAGE AND STOCKPILE A SUFFICIENT AMOUNT OF CLEAN MASONRY BRICKS FREE FROM CHIPS AND CRACKS FOR FUTURE REPAIR OF BUILDING FACADE WHERE THE WALL MEETS THE BUILDING. BRICK REPAIR TO BE DONE BY OTHERS.
- 4. THE EXISTING SCREEN WALL DETAIL HAS BEEN PROVIDED BY OWNER TO ILLUSTRATE THE CONSTRUCTION DETAILING AND FOUNDATION OF THE EXISTING MASONRY WALL TO BE REMOVED.
- 5. ALL EXISTING IRRIGATION LINES DAMAGED OR BROKEN DURING CONSTRUCTION SHALL BE
- 6. EXISTING ELECTRICAL ATTACHED TO THE MASONRY SCREEN WALL TO BE REMOVED SHALL BE PROPERLY ABANDONED PER LOCAL AND STATE CODES



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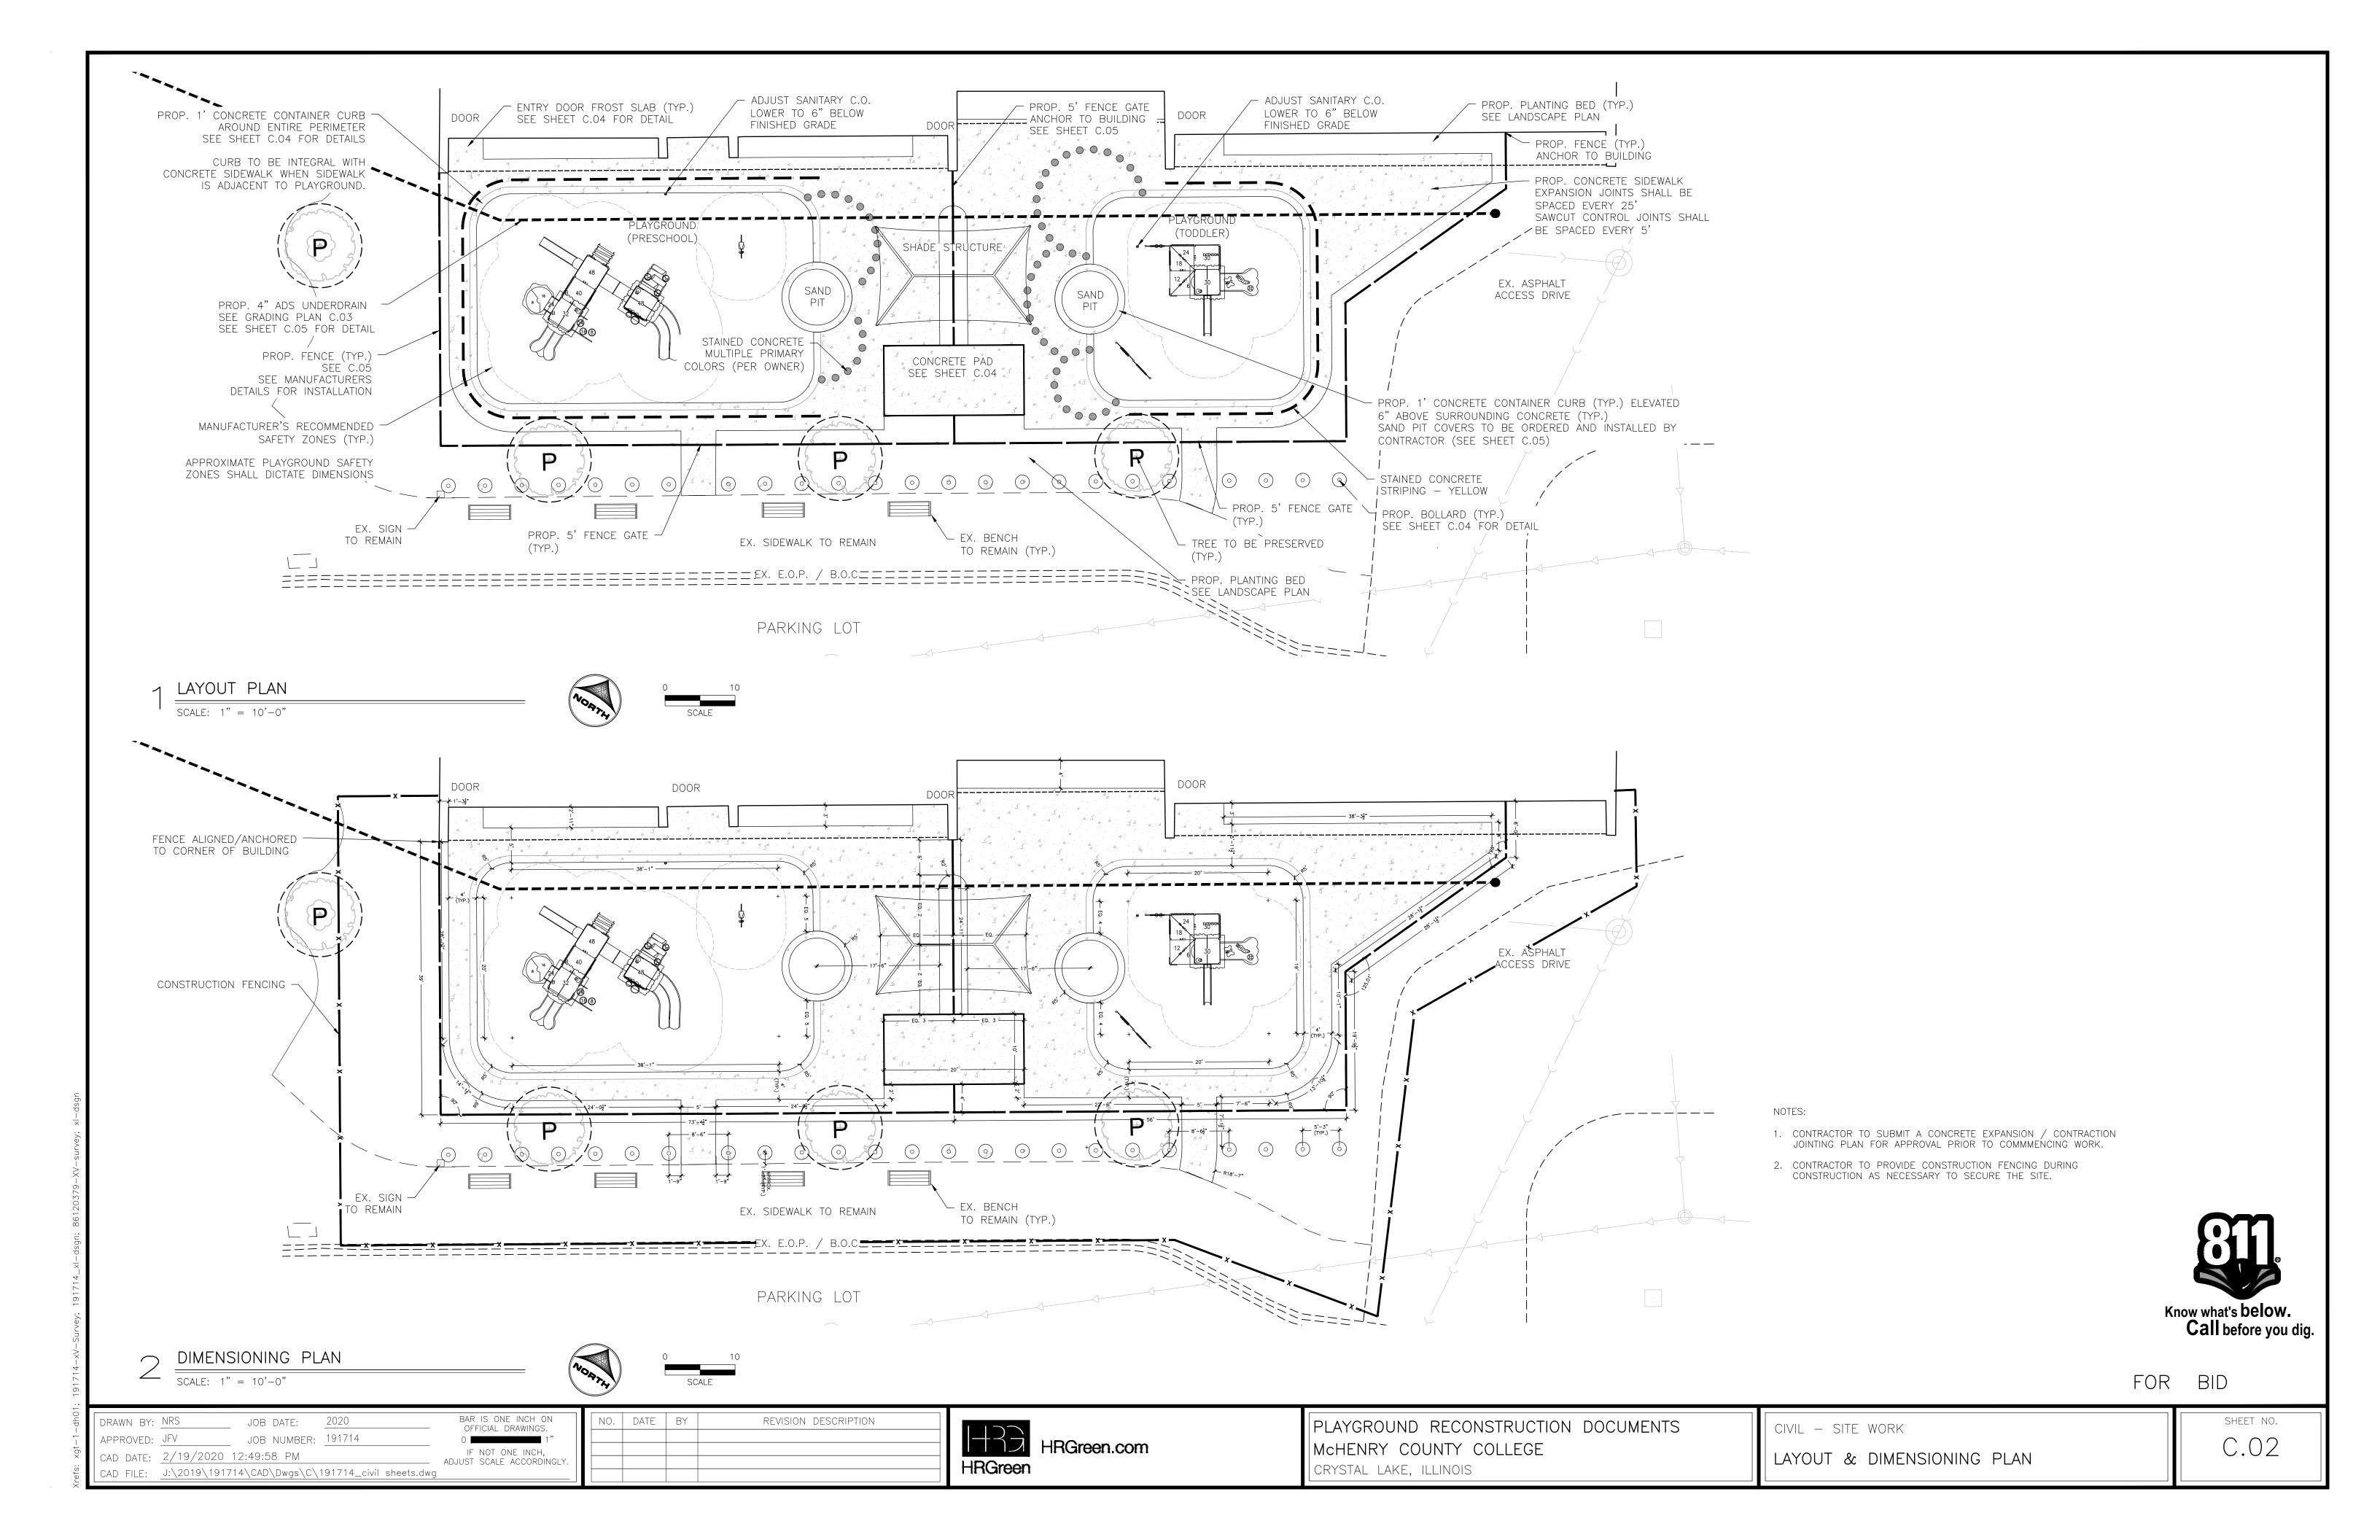



PLAYGROUND RECONSTRUCTION DOCUMENTS McHENRY COUNTY COLLEGE CRYSTAL LAKE, ILLINOIS


CIVIL - SITE WORK

EXISTING CONDITIONS & DEMOLITION PLAN

SHEET NO.



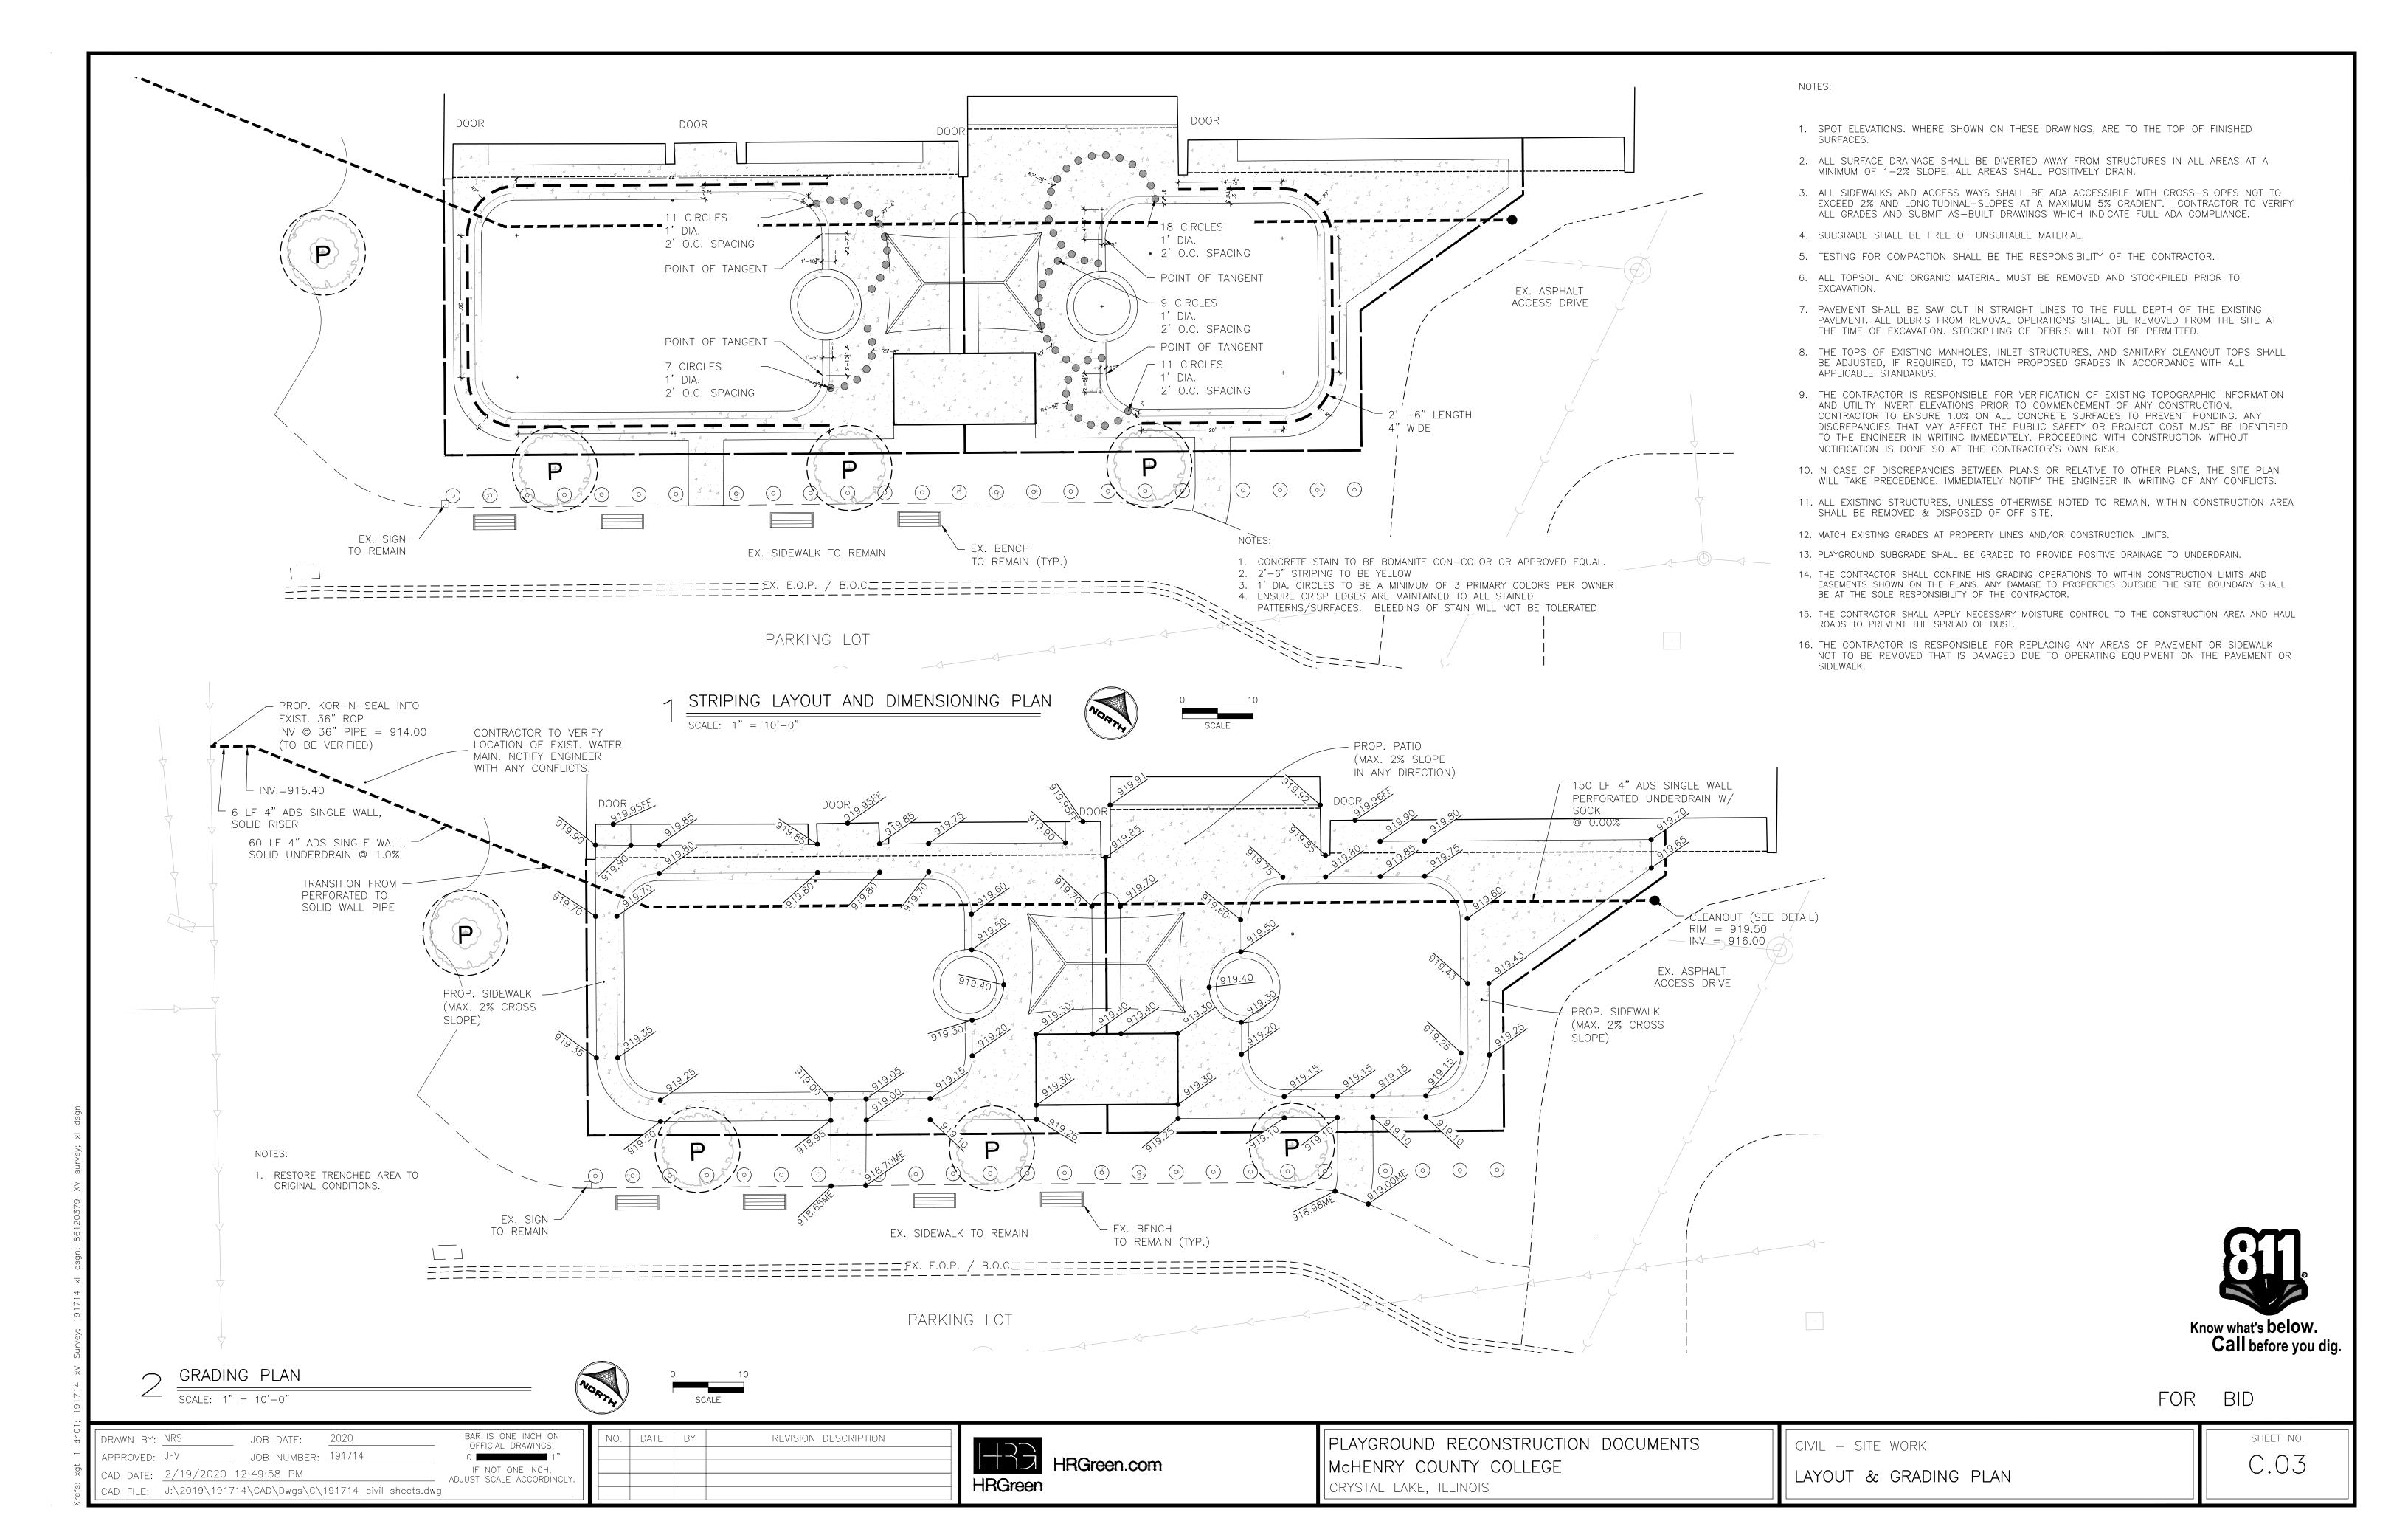

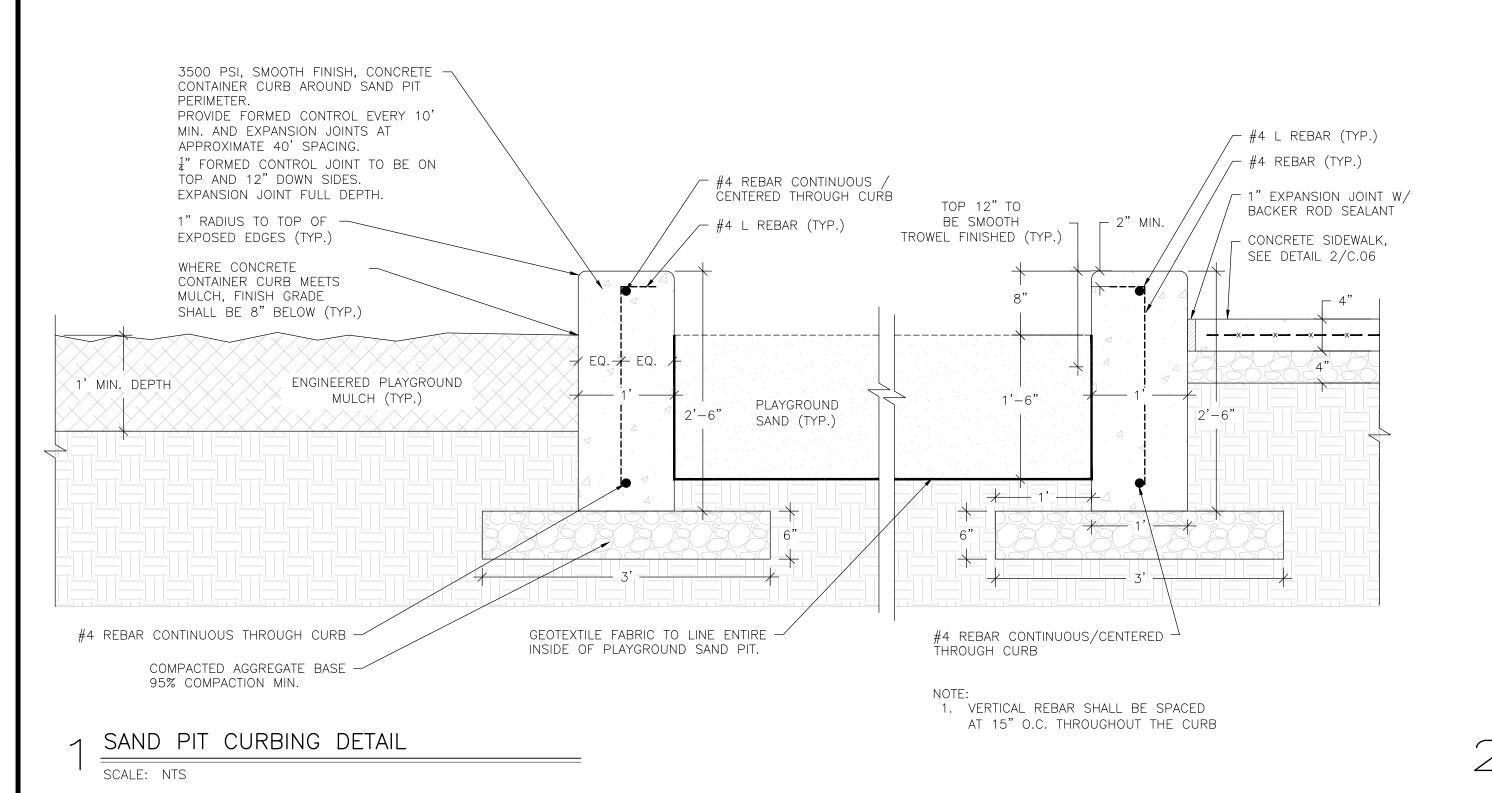

— BLDG. LINE 5'-0" MIN. - 6"x6"x6 GAUGE WELDED WIRE FABRIC SEATED AND SECURED ON STANDS JOINT - MATCH SIDEWALK SECTION SIDEWALK FOR CONCRETE (4" MIN.) 1:50 MAX. (2%) SLOPE - 2" XPS RIGID FOAM INSTALLATION - MATCH SIDEWALK SECTION FOR AGGREGATE BASE (4" MIN.) - PREPARED AND COMPACTED SUBGRADE - DOWEL JOINT

ENTRY DOOR FROST SLAB DETAIL SCALE: NTS


TROWELED, ROUNDED -CONCRETE 6" STEEL PIPE (SCHEDULE 80) — FILLED WITH CONCRETE CENTERED IN FOOTING PAINT BOLLARD WITH DARK BRONZE -TONE EXTERIOR ENAMEL PAINT ANCHOR STEEL PIPE IN -3'-0" CONCRETE FOOTING, 2'-0" DIAMETER X 2'-6" DEPTH 4" MIN. TOPSOIL / SOD -


CONCRETE BOLLARD DETAIL

SCALE: NTS

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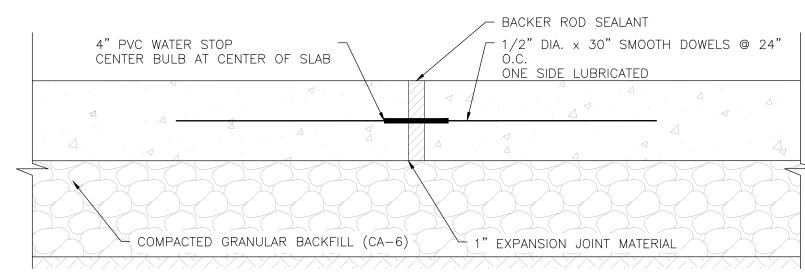
BOLLARDS SHALL BE CLEANED, SCOFFED AND PRIMED UTILIZING A SELF-ETCHING PRIMER PRIOR TO APPLYING PAINT. PAINT SHALL BE A RUST RESISTANT PROTECTIVE ENAMEL FOR METAL SUBSTRATES. PAINT TYPE SHALL BE IDENTIFIED AND SUBMITTED FOR APPROVAL TO THE ENGINEER.



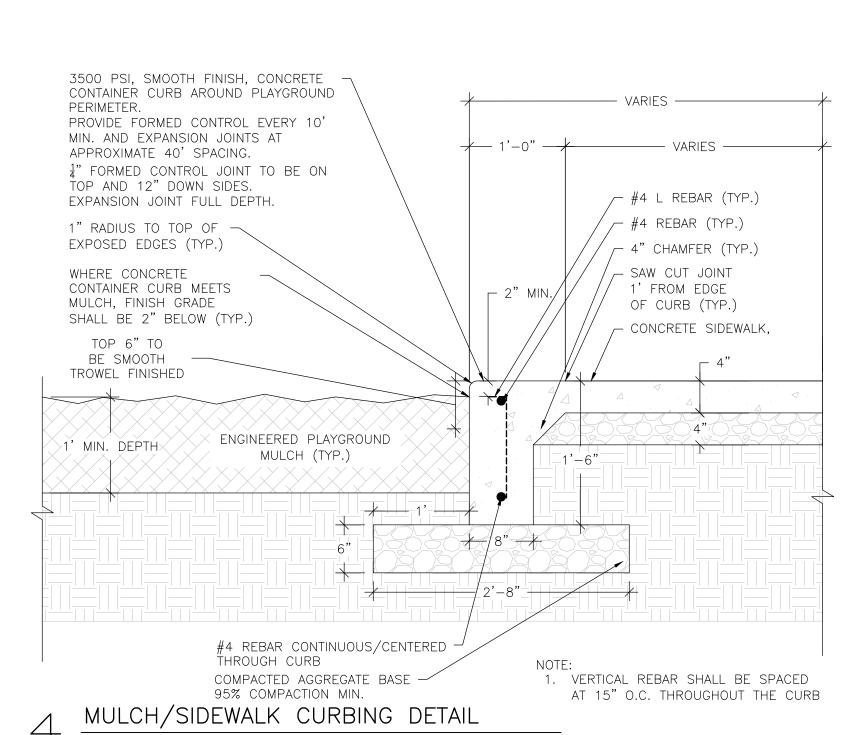


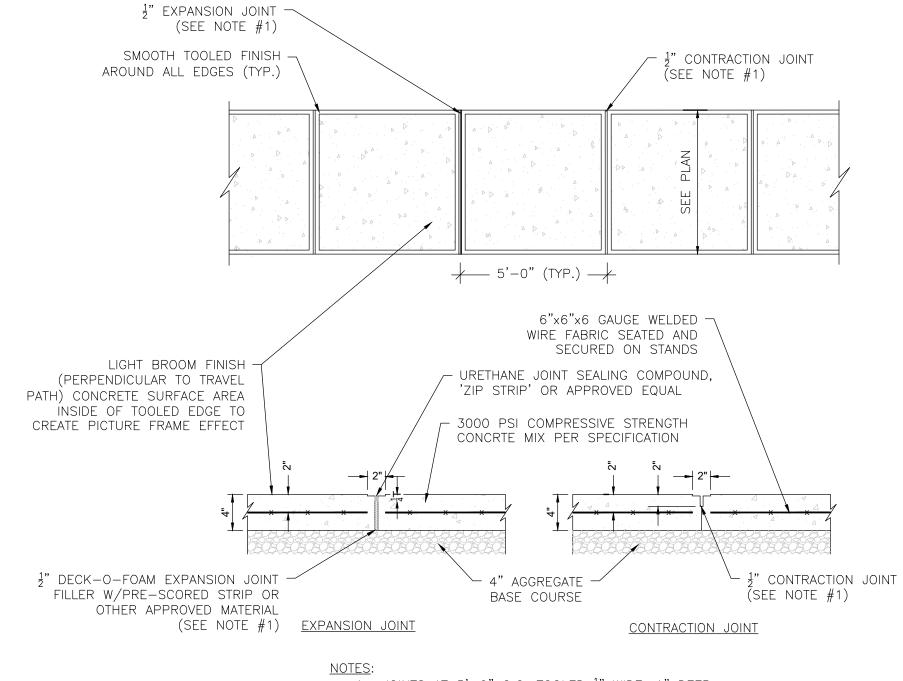1. JOINTS AT 5'-0" O.C. TOOLED $\frac{1}{2}$ " WIDE, 1" DEEP OR MAX. $\frac{D}{4}$ DEEP WHICHEVER IS GREATER. EXPANSION JOINTS AT 20' MAX. & ALL P.C.s, UNLESS APPROVED OR INDICATED OTHERWISE ON PLAN VIEW JOINT PATTERN TO BE PROVIDED BY CONTRACTOR.

CONCRETE SIDEWALK DETAIL



TYP. SECTION: DOWEL JOINT DETAIL SCALE: NTS

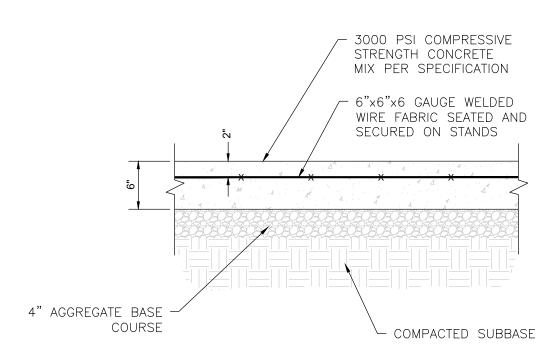

CONCRETE PAVEMENT 10' X 20' PAD DETAIL SCALE: NTS



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SCALE: NTS

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PLAYGROUND RECONSTRUCTION DOCUMENTS McHENRY COUNTY COLLEGE CRYSTAL LAKE, ILLINOIS

CIVIL - SITE WORK DETAILS

SHEET NO.

SCALE: NTS

HRGreen



CONTACT INFORMATION: MICHELLE WALSH NUTOYS LEISURE PRODUCTS (708)579-9055 OFFICE MICHELLEW@NUTOYS4FUN.COM

McHenry County College Crystal Lake, IL

DESCRIPTION

		Toddler Area
tructure:		
1	137966A	Critter Canyon Climber 30"Dk DB
2	179349A	Kick Plate 8"Rise
1	111239A	Square Deck Extension
1	111237A	Square Tenderdeck
4	117495A	Triangular Tenderdeck
2	179362A	Tri-Deck Kick Plate 8"Rise
1	111282A	Bubble Panel Above Deck
1	113211A	Chimes Panel Above Deck
1	124333A	Hourglass Panel Ground Level
2	173586A	Recycled Wood-Grain Lumber Panel Above Deck
1	188836A	Sign Language Panel Above Deck
2	119977A	Handbar
4	111396M	119"Post For Roof DB
1	111397H	69"Post DB
1	111397K	78"Post DB
1	111397L	84"Post DB
1	111397E	90"Post DB
2	111397M	96"Post DB
1	211191A	Tree House Roof w/Stack and w/Kids Only sign
1	166076A	Infant Single Slide DB
ite Furnisł	nings:	

175949A Toddler Picnic Table

		PreSchool Area
1	183195A	Log Stack Climber 48"Deck w/Wood-Grain Handholds DB
1	185861C	Log Stepper 32"Deck w/2 Recycled Wood-Grain Handholds 1 Handloop an
1	185862C	Wood Plank Wiggle Ladder 48"Deck 2" SM
2	179349A	Kick Plate 8"Rise
4	111237A	Square Tenderdeck
1	173585A	Tree Stump Transfer Module 32"Deck DB Only
1	177713A	Color Splash Panel Ground Level
3	173586A	Recycled Wood-Grain Lumber Panel Above Deck
1	164146A	Rock-N-Ring Panel Ground Level
2	111397B	114"Post DB

COMPLETE PLAY STRUCTURE FURNISHING LIST

SCALE:

NOTE:

CONTRACTOR TO ORDER AND INSTALL PLAY STRUCTURE EQUIPMENT PER MANUFACTURER SPECIFICATIONS AND POSITION WITHIN THE DESIGNATED PLAY AREA SO ALL MANUFACTURER SAFETY ZONE REQUIREMENTS ARE MET.

NOTE:



1. ALL PLAY STRUCTURE EQUIPMENT SHALL BE DIRECT BURIED. SEE MANUFACTURER DETAILS FOR INSTALLATION.

McHenry County College Crystal Lake, IL

QTY.	<u>NO.</u>	DESCRIPTION
2	111397A	128"Post DB
4	111396C	129"Post For Roof DB
4	111396B	137"Post For Roof DB
2	211191A	Tree House Roof w/Stack and w/Kids Only sign
1	178768A	Double Swirl Slide 48"Dk DB
1	137967A	Lava Run Slide 32"Dk DB
1	133668A	Single Slide 48"Dk DB
1	128953B	56" Crawl Tunnel 56" w/o View Above Deck
Shade:		SkyWays Two-Post Hip 14'x22' Shade 10' Entry Heig
1	237676F	w/Rapid Release1
Site Furnitu	re:	
2	175949A	Toddler Picnic Table
		Toddler Area
Panels:		.ms. 9.5
1	113211A	Chimes Panel Ground Level
1	173570A	Xylofun Panel Ground Level
3	111397H	69"Post DB
		PreSchool Area

Zeager Bros. Inc. Woodchips

100 Cu.Yd. Woodcarpet. Includes freight.

1 233060B DigiRider Horse DB

Please ensure there are ample clearances for tractor trailer deliveries (10'Wx14'H Minimum). * Installation and maintenance instructions and warranty info available at www.zeagar.com.

	PLAYGROUND CONSTRUCTION DOCUMENTS - McHENRY COUNTY COLLEGE							
	February 20, 2020							
			FURNISHINGS SCHEDULE					
QTY	ITEM	MANUFACTURER & MODEL	MATERIAL & FINISH	CONTACT INFORMATION	REMARKS			
2 EA	SANDBOX COVER	SANDBOX COVERS USA WEIGHTED EDGE SANDBOX COVER SIZE: 10' DIAMETER	MATERIAL: FULL VINYL COLOR: GREEN TOP W/ YELLOW SAFETY STRIPS	MANUFACTURER: SANDBOX COVERS USA PHONE: (877) 840-0707	CONTRACTOR TO CONFIRM SANBOX DIMINSIONS PRIOR TO ORDERING SUBSTITUTIONS TO BE APPROVED BY OWNER PRIOR TO PURCHASE			
244 L.F.	FENCE & GATES	SUPERIOR ALUMINUM PRODUCTS, INC. SERIES 7000 ALUMINUM PICKET FENCE - STYLE K, 3" HEIGHT: 4' STYLE C - SINGLE GATE W/ LOKKLATCH SYSTEM	ALUMINUM COLOR: DARK BRONZE	MANUFACTURER: SUPERIOR ALUMINUM PRODUCTS, INC PHONE: (937) 526-4065	SEE MANUFACTURER'S SPECIFICATIONS AND DETAILS FOR INSTALLATION SUBSTITUTIONS TO BE APPROVED BY OWNER PRIOR TO PURCHASE			

NO. DATE BY

*PROVIDE LISTED MODELS OR APPROVED EQUALS

SITE FURNISHING LIST

SCALE: NTS

Color Sheet

Rep Organization: NuToys Leisure Quote No: CYL20MCC3-3-2 Products, Inc.


Project Title: McHenry County College

PlayShaper® (6-23 months)	AH: Brown/Limon/Leaf/Limon
Direct Bury Aluminum	Art. Browny Limony Leary Limon
STRUCTURE COLORS	
Proshield® Finish	
Posts/Arches: Brown	
Clamps/Ball Connectors: Limon	
Polyethylene	
Slides/Tunnels/Gliders/E-Pods®: Leaf	
Permalene®	
Primary Permalene: 🛟 Recycled Limon	w/Black
Secondary Permalene: 🚱 Recycled Leaf w	ı/Black
Tendertuff	
Barriers/Ladders/Benches: Brown	
Decks/Step Ladders: Brown	

PlayShaper® (2-5 years)	* Palette Overridden * 📐
Mixed Bury Aluminum	AH: Brown/Limon/Leaf/Limon
STRUCTURE COLORS	
Proshield® Finish	
Posts/Arches: Brown	
Clamps/Ball Connectors: Elmon	
Play Components: Limon	
Polyethylene	
Slide Hoods/O-Zone®: Eaf	
Slides/Tunnels/Gliders/E-Pods®: Eaf	
Permalene®	
Primary Permalene: 😱 Recycled Limon w/Black	
Secondary Permalene: 😱 Recycled Leaf w/Black	
Tendertuff	
Barriers/Ladders/Benches: Brown	
Decks/Step Ladders: Brown	
Shade	
Shade Posts: Tan	
Upper Sails: Beige FR*	


COMPLETE PLAY STRUCTURE COLOR LIST

Page **1** of **1**

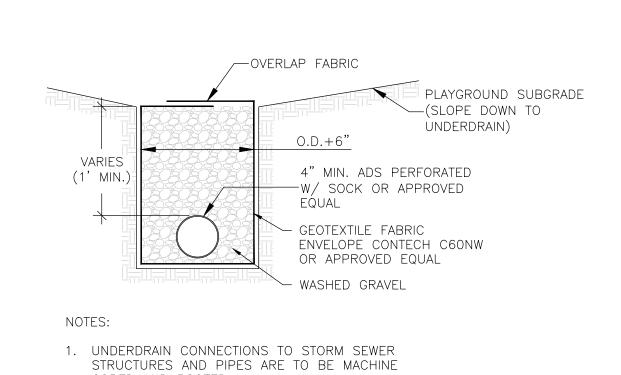

CORED AND BOOTED.

UNDERDRAIN DETAIL SCALE: NTS

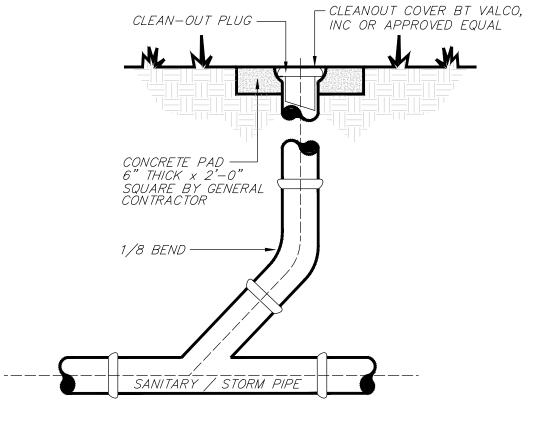

CLEANOUT DETAIL SCALE: NTS

FOR BID

DRAWN BY:	NRS	JOB DATE:	2020	BAR IS ONE INCH ON OFFICIAL DRAWINGS.
APPROVED:	JFV	JOB NUMBER:	191714	0 11101/12 111/14/11/03:
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REVISION DESCRIPTION


HRGreen

PLAYGROUND RECONSTRUCTION DOCUMENTS McHENRY COUNTY COLLEGE CRYSTAL LAKE, ILLINOIS


CIVIL - SITE WORK DETAILS

SHEET NO.

HRGreen.com

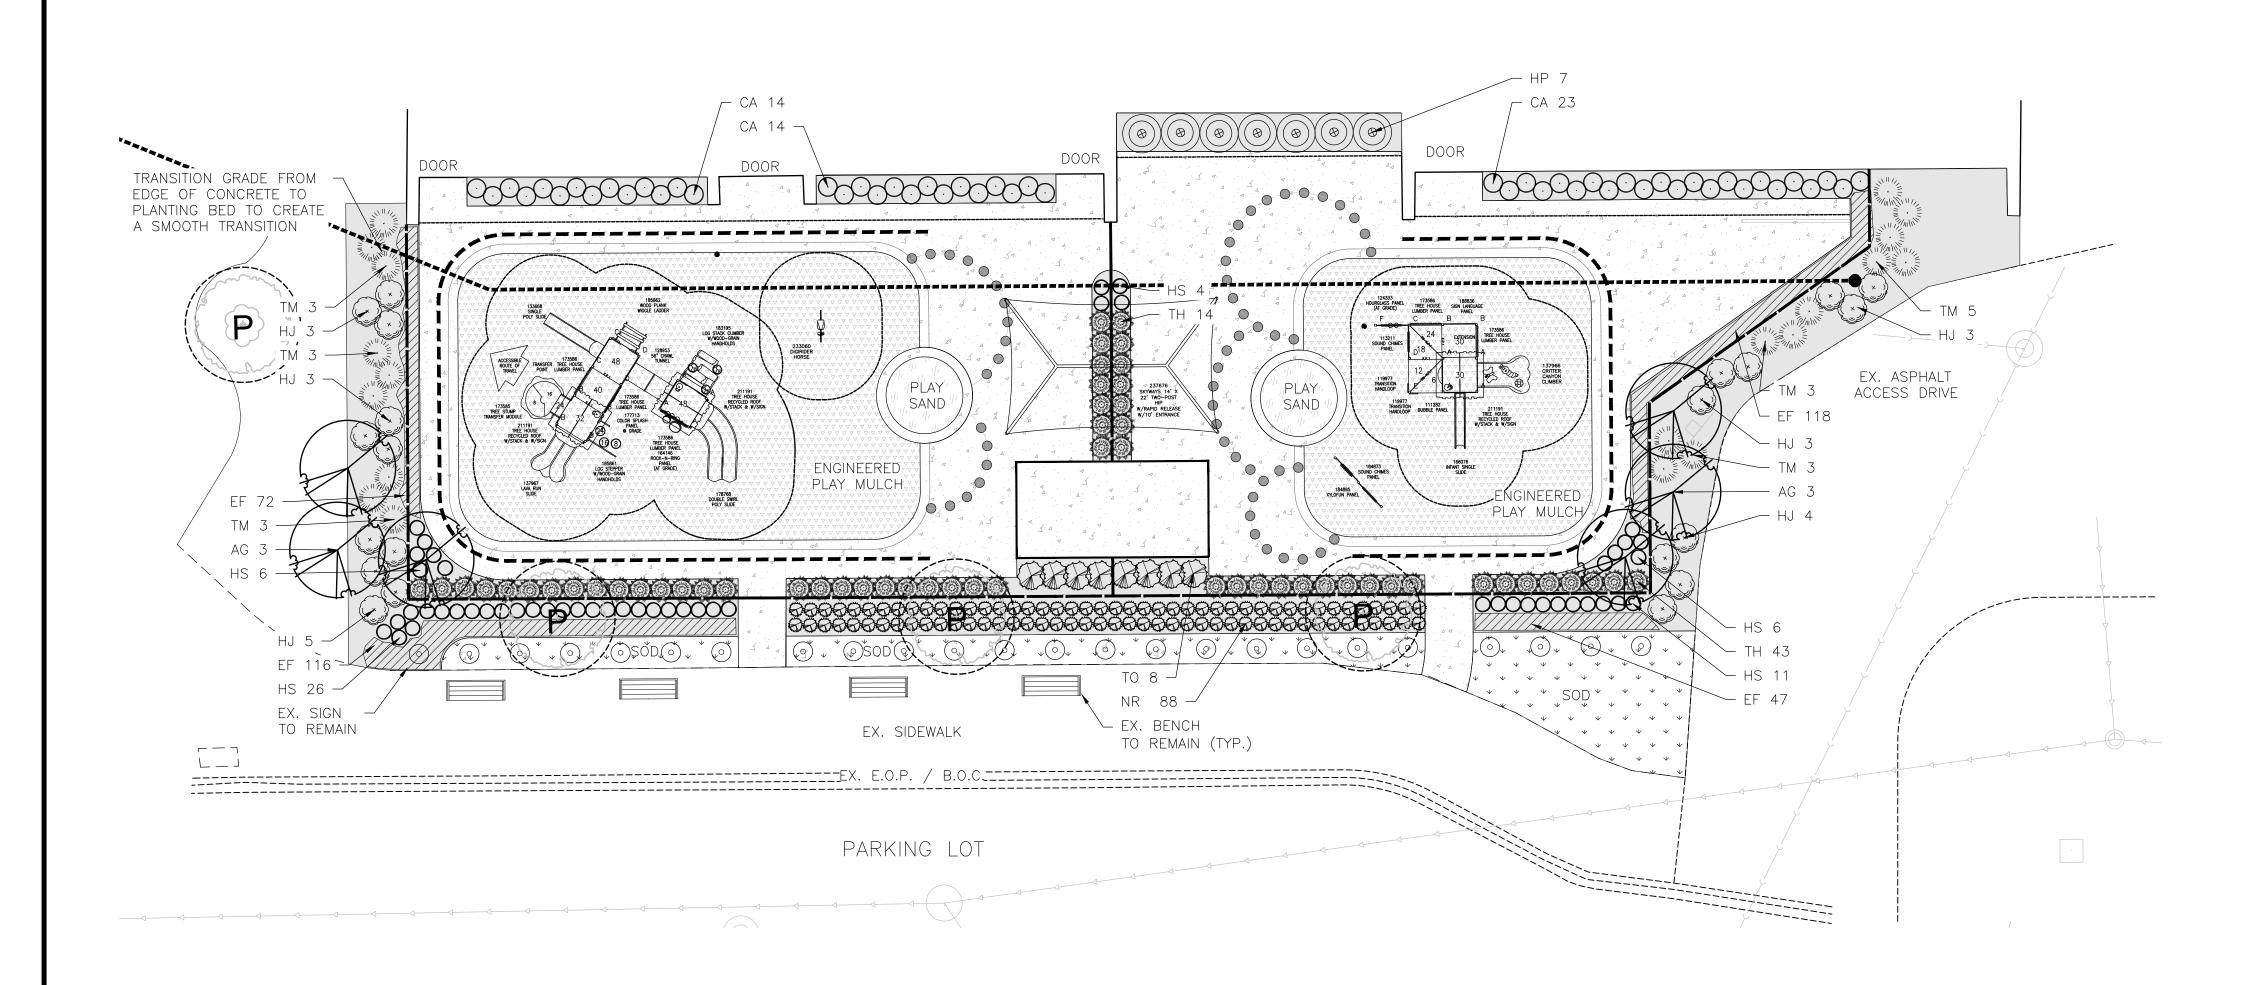

			February 20, 2020			
			MATERIALS SCHEDULE			
QTY	KEY	BOTANICAL NAME/ITEM	COMMON NAME	SIZE	COND	REMARKS
	JS TREES			·		
6	AG	AMELANCHIER X GRANDIFLORA 'AUTUMN BRILLIANCE'	AUTUMN BRILLIANCE SERVICEBERRY	8' HT.	B&B	MULTI-STEMMED; MATCHED
VERGRE	EN TREES					
8	то	THUJA OCCIDENTALIS 'SMARAGD'	EMERALD GREEN ARBORVITAE	#5	CONT.	3' O.C.; MATCHED
ECIDUOL	JS SHRUBS					
21	HJ	HYDRANGEA PANICULATA 'JANE'	LITTLE LIME HYDRANGEA	#3	CONT.	3' O.C.; MATCHED
7	HP	HYDRANGEA PANICULATA 'ILVOBO'	BOBO HYDRANGEA	#3	CONT.	4' O.C.; MATCHED
EVERGRE	EN SHRUBS	S				
57	TH	TAXUS X MEDIA 'HICKSII'	HICKS YEW	#5	CONT.	2.5' O.C.; MATCHED
20	TM	TAXUS X MEDIA 'DENSIFORMIS'	DENSIFORMIS YEW	#5	CONT.	3' O.C.; MATCHED
PERENNIA	LS, GRASS	SES & GROUNDCOVER				
51	CA	CALAMAGROSTIS X ACUTIFLORA 'KARL FOERSTER'	FEATHER REED GRASS	#1	CONT.	24" O.C.; MATCHED
353	EF	EUONYMUS FORTUNEI VAR. 'COLORATUS'	PURPLE WINTERCREEPER	1 CELL OF 24 FLAT	CONT.	10" O.C.; MATCHED
53	HS	HEMEROCALLIS 'STELLA DE ORO'	DAYLILY	#1	CONT.	18" O.C.; MATCHED
88	NR	NEPETA RACEMOSA 'WALKER'S LOW'	WALKER'S LOW CATMINT	#1	CONT.	18" O.C.; MATCHED
MISCELLA	NEOUS					
65	SOD	SEE NOTE BELOW		SY		
21	MULCH	3" DEEP SHREDDED HARDWOOD MULCH		CY		
	NOTES:					

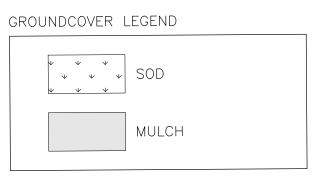

PLAYGROUND SURFACING LEGEND engineered mulch // // // PLAY SAND




LANDSCAPE PLAN

SCALE: 1" = 10'-0"

BAR IS ONE INCH ON OFFICIAL DRAWINGS.

0 1"

IF NOT ONE INCH,
—— ADJUST SCALE ACCORDINGLY.

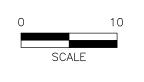


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PLAYGROUND RECONSTRUCTION DOCUMENTS McHENRY COUNTY COLLEGE CRYSTAL LAKE, ILLINOIS

LANDSCAPE LANDSCAPE PLAN FOR BID SHEET NO.


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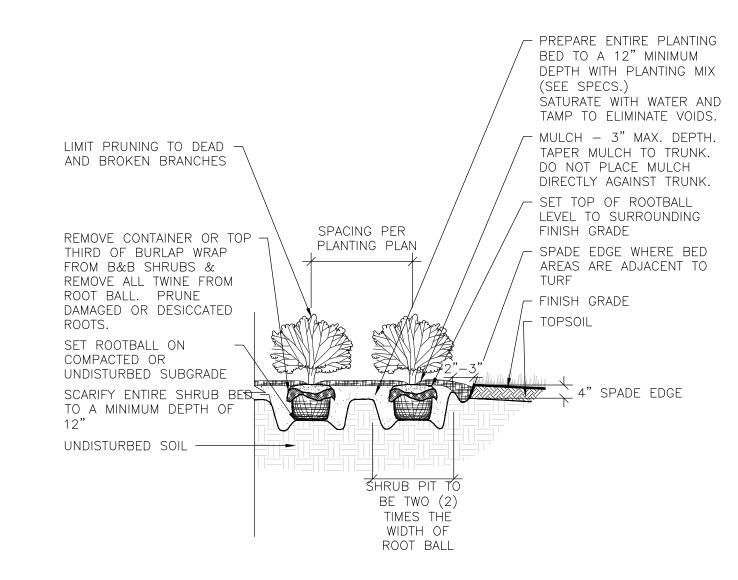
1 TYP. ORNAMENTAL TREE PLANTING DETAIL

SCALE: NTS

TURF SIDE PLANTING BED SIDE

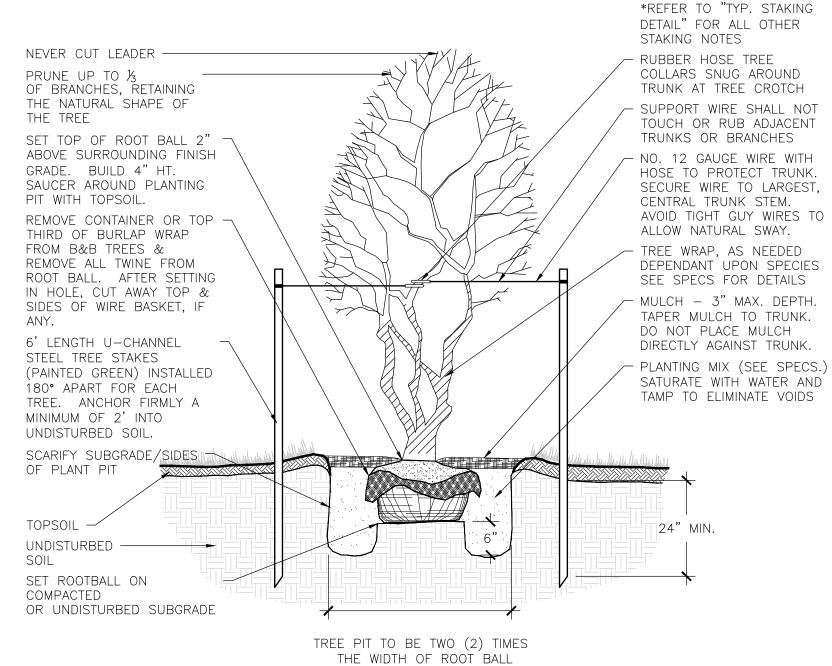


"V" TRENCH BED EDGING

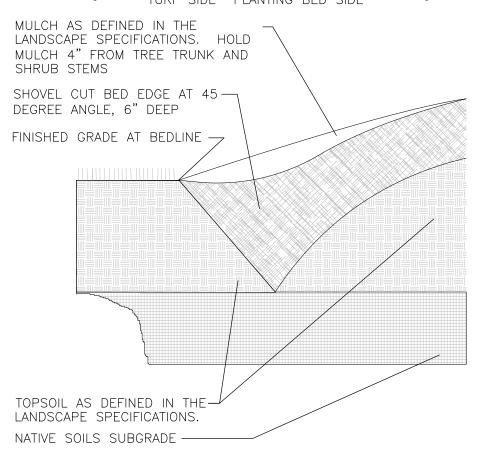

TYP. SHRUB PLANTING DETAIL

SCALE: NTS

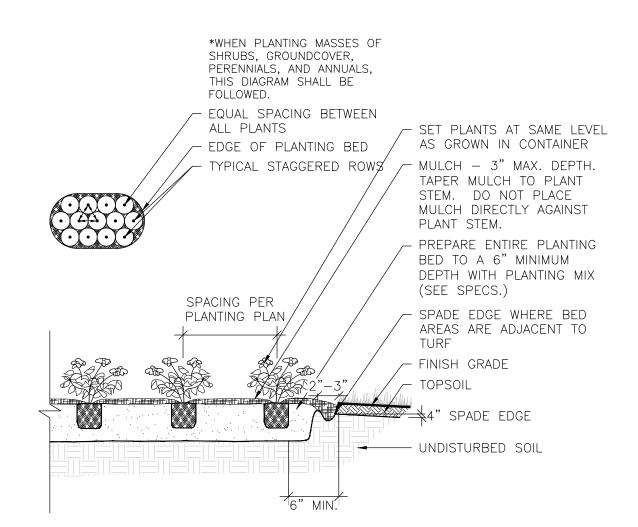

TYP. PERENNIAL PLANTING DETAIL

SCALE: NTS

Know what's below.

Call before you dig.

FOR BID

SHEET NO.

BAR IS ONE INCH ON OFFICIAL DRAWINGS. _____ JOB DATE: <u>2020</u> DRAWN BY: NRS APPROVED: JFV JOB NUMBER: 191714 IF NOT ONE INCH,
—— ADJUST SCALE ACCORDINGLY. CAD DATE: 2/19/2020 12:53:23 PM CAD FILE: J:\2019\191714\CAD\Dwgs\L\191714_landscape sheets.dwg

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LANDSCAPE